

DEVELOPMENT PERMIT NO. DP001285

1303320 BC LTD Owner(s) of Land (Permittee)

200 HANSEN ROAD Civic Address

- 1. This development permit is issued subject to compliance with all of the bylaws of the municipality applicable thereto, except as specifically varied or supplemented by this permit.
- 2. This development permit applies to and only to those lands within the municipality described below, and any and all buildings, structures and other developments thereon:

Legal Description:

LOT B , SECTION 14, RANGE 8, MOUNTAIN DISTRICT, PLAN EPP76054 PID No. 030-471-656

3. The land described herein shall be developed strictly in accordance with the following terms and conditions and provisions of this permit and any plans and specifications hereto which shall form a part thereof.

Schedule ASubject Property MapSchedule BSite & Parking PlanSchedule CParking ScheduleSchedule DBuilding Elevations and DetailsSchedule ELandscape Plan & Details

- 4. If the landowner does not substantially start any construction with respect to which this permit was issued within two years after the date it was issued, the permit lapses.
- 5. This permit is not a building permit nor does it constitute approval of any signage. Separate applications must be made for a building permit and sign permit.
- 6. This permit prevails over the provisions of the bylaw in the event of conflict.

- Page 2 -

PERMIT TERMS

The "City of Nanaimo Zoning Bylaw 2011 No. 4500" is varied as follows:

1. Section 7.6.1 Size of Buildings – to increase the maximum permitted building height for a principal building from 14.0m to 14.8m.

CONDITIONS OF PERMIT

1. The subject property shall be developed substantially in accordance with the Site and Parking Plan, prepared by Joyce Reid Troost Architecture, dated 2022-JUL-22, as shown on Schedule B.

2. The subject property shall be developed in substantial compliance with the Building Elevations and Details, prepared Joyce Reid Troost Architecture, dated 2022-JUL-22, as shown on Schedule D.

3. The subject property shall be developed in substantial compliance with the Landscape Plan and Details prepared by Small & Rossell Landscape Architects Inc., dated 2023-AUG-29, as shown on Schedule E.

4. The registration of a Statutory Right-of-Way to secure a public vehicle turnaround at the south end of Hansen Road prior to Building Permit issuance.


5. The construction of the trail within Hansen Road and through the adjacent strata development at 1601 Creekside Drive to connect to Caspers Way will be required prior to Final Building Occupancy.

REVIEWED AND APPROVED ON

Dáte

J.Holm Director of Planning & Development Pursuant to Section 154 (1)(b) of the Community Charter


PC/bb Prospero attachment: DP001285

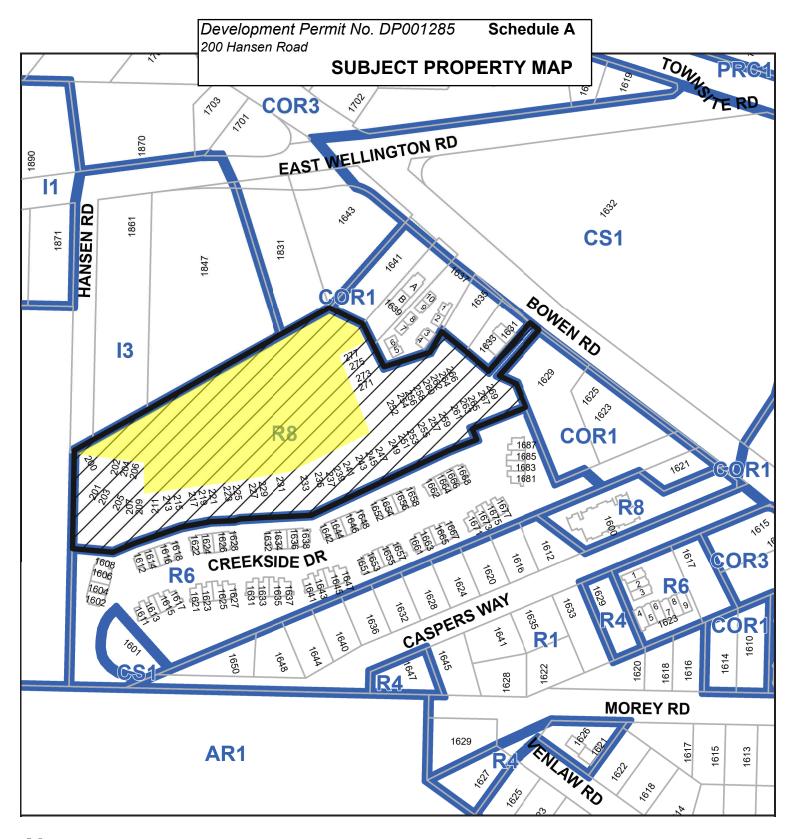





PHASE 2 AREA

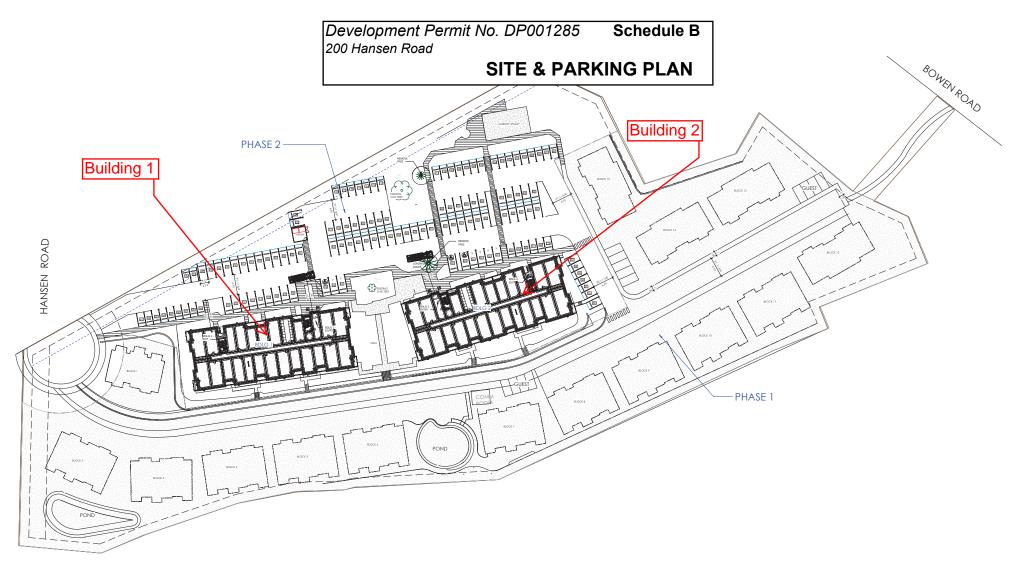

① SITE 1/32" = 1'-0"

> JOYCE REID TROOST ARCHITECTURE 2515 GLENAYR DRIVE NANAIMO, BC V9S 3R9 ARCH. STAMP CLIENT REV. DATE NUMBER DESCRIPTION JULY 22, 2022 SITE I ADDI NELESSA DARMARE DI I CANDINESSA DI CONTRURSIONO DI COMMUNENTI DE CONTRURSIONE DI CONTRUTINO DI CONTRUTINO DI CONTRUCTORI DI CONTRU DI CONTRUTINO DI CONTRUTI DI CONTRUITO DI CONTRUITO COMMUNENTI DI CONTRUTI DI CONTRUITO DI CONTRUITO DI CONTRUTTO DI CONTRUITO DI CONTRUINO DI CONTRUITO DI CONTRUIDI DI CONTRUITO DI 1/32" = 1'-0" SCALE 1303320 BC LTD HANSEN APTS. ovce@irtarchitecture.com A009 200 HANSEN ROAD, NANAMO, BC 250.714.8749 tarchitecture.com DRAWN BY JRT CHECKED BY JRT

Development Permit No. DP001285 Schedule C 200 Hansen Road

PARKING SCHEDULE

PARKI	NG	PARK	PARKING		ING	PARKI	PARKING			
#	TYPE	#	TYPE	#	TYPE	#	TYPE			
19	ACCESSIBLE - STANDARD - EV LEVEL 2	118	SMALL CAR - EV ROUGH IN	40	STANDARD - EV ROUGH-IN	75	STANDARD - EV ROUGH-IN			
22	ACCESSIBLE - STANDARD - EV LEVEL 2	30	I.	41	STANDARD - EV ROUGH-IN	76	STANDARD - EV ROUGH-IN			
23	ACCESSIBLE - STANDARD - EV LEVEL 2	01	SMALL CAR - EV LEVEL 2	42	STANDARD - EV ROUGH-IN	77	STANDARD - EV ROUGH-IN			
3		02	SMALL CAR - EV LEVEL 2	43	STANDARD - EV ROUGH-IN	78	STANDARD - EV ROUGH-IN			
3	SMALL CAR - EV ROUGH IN	03	SMALL CAR - EV LEVEL 2	44	STANDARD - EV ROUGH-IN	79	STANDARD - EV ROUGH-IN			
34	SMALL CAR - EV ROUGH IN	04	SMALL CAR - EV LEVEL 2	45	STANDARD - EV ROUGH-IN	80	STANDARD - EV ROUGH-IN			
5	SMALL CAR - EV ROUGH IN	05	SMALL CAR - EV LEVEL 2	46	STANDARD - EV ROUGH-IN	81	STANDARD - EV ROUGH-IN			
6	SMALL CAR - EV ROUGH IN	06	SMALL CAR - EV LEVEL 2	47	STANDARD - EV ROUGH-IN	82	STANDARD - EV ROUGH-IN			
37	SMALL CAR - EV ROUGH IN	07	SMALL CAR - EV LEVEL 2	48	STANDARD - EV ROUGH-IN	83	STANDARD - EV ROUGH-IN			
8	SMALL CAR - EV ROUGH IN	08	SMALL CAR - EV LEVEL 2	49	STANDARD - EV ROUGH-IN	84	STANDARD - EV ROUGH-IN			
39	SMALL CAR - EV ROUGH IN	09	SMALL CAR - EV LEVEL 2	50	STANDARD - EV ROUGH-IN	85	STANDARD - EV ROUGH-IN			
96	SMALL CAR - EV ROUGH IN	28	SMALL CAR - EV LEVEL 2	52	STANDARD - EV ROUGH-IN	86	STANDARD - EV ROUGH-IN			
)7	SMALL CAR - EV ROUGH IN	29	SMALL CAR - EV LEVEL 2	53	STANDARD - EV ROUGH-IN	87	STANDARD - EV ROUGH-IN			
8	SMALL CAR - EV ROUGH IN	30	SMALL CAR - EV LEVEL 2	54	STANDARD - EV ROUGH-IN	88	STANDARD - EV ROUGH-IN			
9	SMALL CAR - EV ROUGH IN	31	SMALL CAR - EV LEVEL 2	55	STANDARD - EV ROUGH-IN	89	STANDARD - EV ROUGH-IN			
00	SMALL CAR - EV ROUGH IN	32	SMALL CAR EV LEVEL 2	56	STANDARD EV ROUGH IN	90	STANDARD EV ROUGH IN			
01	SMALL CAR - EV ROUGH IN	119	SMALL CAR - EV LEVEL 2	57	STANDARD - EV ROUGH-IN	91	STANDARD - EV ROUGH-IN			
02	SMALL CAR - EV ROUGH IN	120	SMALL CAR - EV LEVEL 2	58	STANDARD - EV ROUGH-IN	92	STANDARD - EV ROUGH-IN			
03	SMALL CAR - EV ROUGH IN	121	SMALL CAR - EV LEVEL 2	59	STANDARD - EV ROUGH-IN	93	STANDARD - EV ROUGH-IN			
04	SMALL CAR - EV ROUGH IN	122	SMALL CAR - EV LEVEL 2	60	STANDARD - EV ROUGH-IN	94	STANDARD - EV ROUGH-IN			
05	SMALL CAR - EV ROUGH IN	123	SMALL CAR - EV LEVEL 2	61	STANDARD - EV ROUGH-IN	95	STANDARD - EV ROUGH-IN			
06	SMALL CAR - EV ROUGH IN	19		62	STANDARD - EV ROUGH-IN	55	•			
07	SMALL CAR - EV ROUGH IN	10	STANDARD - EV LEVEL 2	63	STANDARD - EV ROUGH-IN	20	VISITOR - STANDARD - EV LEVEL 2			
08	SMALL CAR - EV ROUGH IN	11	STANDARD - EV LEVEL 2	64	STANDARD - EV ROUGH-IN	21	VISITOR - STANDARD - EV LEVEL 2			
09	SMALL CAR - EV ROUGH IN	12	STANDARD - EV LEVEL 2	65	STANDARD - EV ROUGH-IN	24	VISITOR - STANDARD - EV LEVEL 2			
10	SMALL CAR - EV ROUGH IN	13	STANDARD - EV LEVEL 2	66	STANDARD - EV ROUGH-IN	25	VISITOR - STANDARD - EV LEVEL 2			
11	SMALL CAR - EV ROUGH IN	14	STANDARD - EV LEVEL 2	67	STANDARD - EV ROUGH-IN	26	VISITOR - STANDARD - EV LEVEL 2			
12	SMALL CAR - EV ROUGH IN	15	STANDARD - EV LEVEL 2	68	STANDARD - EV ROUGH-IN	27	VISITOR - STANDARD - EV LEVEL 2			
13	SMALL CAR - EV ROUGH IN	16	STANDARD - EV LEVEL 2	69	STANDARD - EV ROUGH-IN	6				
14	SMALL CAR - EV ROUGH IN	17	STANDARD - EV LEVEL 2	70	STANDARD - EV ROUGH-IN	123				
15	SMALL CAR - EV ROUGH IN	18	STANDARD - EV LEVEL 2	71	STANDARD - EV ROUGH-IN					
16	SMALL CAR - EV ROUGH IN	51	STANDARD - EV LEVEL 2	72	STANDARD - EV ROUGH-IN					
17	SMALL CAR - EV ROUGH IN	10		73	STANDARD - EV ROUGH-IN	_	RECEI			
				74	STANDARD - EV ROUGH-IN		RECEI DP12			

Development Permit No. DP001285 Schedule D 200 Hansen Road

BUILDING ELEVATIONS & DETAILS

Proposed building

Proposed building height variance

Proposed building

MAX AI

PROPSED HEIGHT 14.8 N

height variance





BUILDING 1

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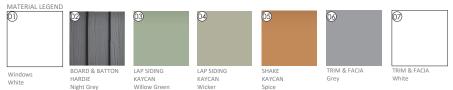
BLDG 1 | NORTH ELEVATION | FROM PARKING LOT | Scale 3/32" = 1' |

Proposed building

height variance

height variance BUILDING 1 05 04 03 PROPSED HEIGHT 14.8 M MAX ALLOWABLE HEIGHT 14 M 02 AT. LEVEL 4 • 2 \square Π LEVEL 3 4 \square \square -• LEVEL 2 2.4 •]] \square Π LEVEL 1 Greek

BLDG 1 | SOUTH ELEVATION | FROMACCESS LANE | Scale 3/32" = 1' |



08

BLDG 1 | EAST ELEVATION | Scale 3/32" = 1' |

BLDG 1 | WEST ELEVATION | Scale 3/32" = 1'

LEVEL 4

LEVEL 3

LEVEL 1

10



JOYCE REID TROOST ARCHITECTURE 2515 GLENAYR DRIVE ANAIMO, BC V95 389	THE DRAWINGS, DESIGN IDEAS AND FEATURES OF CONSTRUCTION DEPICITED HEREIN ARE THE EXCLUSIVE PROPERTY OF JOYCE RED TROOST ARCHITECT, ALL COMMON-COOPY AND PROPERTY RIGHTS ARE EXPRESSLY RESERVED. THEY ARE NOT	ARCH. STAMP		CLIENT	REV. DATE N 22-08-05 0 22-05-01 0	10MBER 1 1 2 0	DESCRIPTION DP DP REV 01	DATE SCALE	JULY 22, 2022 SEE DRAWING	BLDG 1 ELEVATIONS
NANAIMO, BC V95 389 joyce@ijfarchilecture.com 250.714.87.00 jfarchilecture.com	ARE EURPRISELY RESERVED. THEY ARE NOT TO BE REUSED, COPEID, REPRODUCED, OR USED FOR ANY PURPOSES NOR ARE THEY TO BE ASSIGNED TO A THEO PARTY WITHOUT EVERSISED WRITTEN CONSENT, IN THE EVENT OF ANY UNAUTHORIZED USE OF THESE PLANS BY A THRO PARTY, THE THRO PARTY SHALL NOT HOLD JOYCE RED TROCST ARCHITECT REPROVINEL.		HANSEN APTS. 200 hansen; nanalimo; bc	1303320 BC LTD				DRAWN BY J	197	A200

Proposed building height variance		
	BUILDING 2	 PROPSED HEIGHT 14.8 M
		MAX ALLOWABLE HEIGHT 14 M
EXIT STAIRCASE	EXIT STAIRC	

BLDG 2 | NORTH ELEVATION | FROM PARKING LOT | Scale 3/32" = 1' |



BLDG 2 | SOUTH ELEVATION | FROMACCESS LANE | Scale 3/32" = 1' |







BLDG 2 | EAST ELEVATION | Scale 3/32" = 1' |

RECEIVED DP1285 2023-AUG-25

	JOYCE REID TROOST ARCHITECTURE 2515 GLENAYR DRIVE NANAIMO, BC V93 389	THE DRAWINGS, DESIGN IDEAS AND FEATURES OF CONSTRUCTION DEPICTED HEREIN ARE THE EXCLUSIVE PROPERTY OF JOYCE REID TROOST ARCHTECT, ALL COMMEND CODEW AND REDORDER AND AND	ARCH. STAMP		CLIENT	REV. DATE 22-08-05 22-05-01	NUMBER DESCRIPTION 01 DP 02 DP REV 01	DATE JULY 22, 2022 SCALE SEE DRAWING	BLDG 2 ELEVATIONS
Rich	joyce@jrtarchitecture.com 250.714.8749 jrtarchitecture.com	COMMONE-COPY AND PROPERTY BIGHTS ARE EXPRESSIVE. RESERVED. HEY ARE NOT TO BE REUSED. COPIED. REPRODUCED. OR LED TOR ANY PROPENSION ARE HEY WITHOUT EXPRESSION WRITEN CONSENT. IN WITHOUT EXPRESSION WRITEN CONSENT. IN THE EVENT OF ANY UNAUTHORED USE OF HESE FLANS BY A THEO PARTY. HE THEO PARTY SHALL NOT HOLD JOICE RED TROOST ARCHITECT REPONSIBLE.	arcount in a start of the start	HANSEN APTS. 200 hansen, nanaimo, BC	1303320 BC LTD			DRAWN BY JRI	A201

PROPSED HEIGHT 14.8 M

Proposed building height variance

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MAX ALLO

1 100.0

BUILDING 2 04

03 05

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BLDG 2 | WEST ELEVATION | Scale 3/32" = 1' |

LEVEL 4

LEVEL 3

LEVEL 2

LEVEL 1



SOUTH ELEVATION | BLDG 1 & 2 | FROM ACCESS LANE | Scale 1/16" = 1' |



NORTH ELEVATION | BLDG 1 & 2 | FROM PARKING | Scale 1/16" = 1' |

			ARCH. STAMP		CLIENT	REV. DATE	NUMBER	DESCRIPTION	DATE JULY 22, 2022			
1	2515 GLENAYR DRIVE	THE DRAWINGS, DESIGN IDEAS AND FEATURES OF CONSTRUCTION DEPICTED HEREIN ARE THE EXCLUSIVE PROPERTY OF JOYCE REID TROOST ARCHTECT, ALL	STERED AD		Control VI	22-08-05 22-05-01	01	DP DP REV 01	SCALE SEE DRAWING	BLDG 1 & 2 ELEVATIONS		
	NANAIMO, BC V9S 3R9	COMMON-COPY AND PROPERTY RIGHTS ARE EXPRESSLY RESERVED. THEY ARE NOT TO BE REUSED, COPIED, REPRODUCED, OR USED FOR ANY RUPPOSE NOR ARE THEY	No vein the state	HANSEN APTS.								
	joyce@jrtarchitecture.com 250.714.8749	TO BE ASSIGNED TO A THRD PARTY WITHOUT EXPRESSED WRITTEN CONSENT. IN THE EVENT OF ANY UNAUTHORIZED USE OF	Pullet	200 HANSEN, NANAIMO, BC	FAMILY TREE DEVELOPMENTS					A202		
	jrtarchitecture.com	THESE PLANS BY A THRD PARTY, THE THRD PARTY SHALL NOT HOLD JOYCE RED TROOST ARCHITECT RESPONSIBLE.		"ISHCOLUMIN	SHCOLUNIN	"ISHCOLUMIN	SHCOLUMIN					

