

Staff Report for Decision


File Number: DP001275

DATE OF MEETING December 18, 2023

AUTHORED BY CALEB HORN, PLANNER, CURRENT PLANNING

SUBJECT DEVELOPMENT PERMIT APPLICATION NO. DP1275 – 325

WATFIELD AVENUE

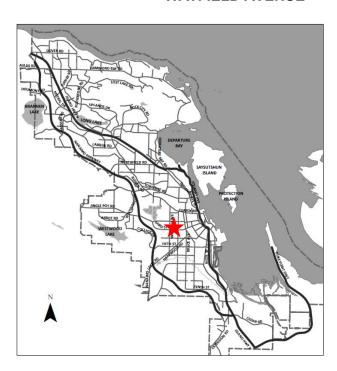

Proposal:

A 171-unit multi-family residential development

Zoning:

COR2 - Mixed Use Corridor

City Plan Land Use Designation:

Mixed-Use Corridor

Development Permit Areas:

DPA8 – Form and Character

Lot Area:

9,241m²







OVERVIEW

Purpose of Report

To present for Council's consideration a development permit application for a multi-family residential development at 325 Watfield Avenue.

Recommendation

That Council issue Development Permit No. DP1275 for a multi-family residential development at 325 Watfield Avenue.

BACKGROUND

A development permit application, DP1275, was received from Ironclad Developments Inc. to permit a multi-family residential development with two buildings and a combined total of 171 dwelling units at 325 Watfield Avenue. The site was previously associated with the mixed-use development at 525 Third Street where the first two phases were completed in 2019 and 2020 (DP1049). The subject property was later subdivided from that project in 2022.

The development concept under DP1049 originally included a 218-bed student housing building and 10 residential townhouse units on the portion of the site now addressed as 325 Watfield Avenue, but the current owner is not pursuing this concept and is proposing to replace it through DP1275. Two remaining mixed-use phases of DP1049 are expected to be completed at 515 Third Street, to the north of the development parcel.

Subject Property and Site Context

The subject property is located in the Harewood Neighbourhood. The lot is on the west side of Watfield Avenue just south of Third Street, and is irregularly shaped with an approximate width of 60m and approximate depth of 150m. The site is presently vacant and slopes downhill by approximately 9m from east to west.

The surrounding neighbourhood consists of a mix of residential and commercial uses. Adjacent land uses include townhouses on Hillcrest Avenue to the west (DP1049 Phase 1), a 4-storey mixed-use building to the northwest (DP1049 Phase 2), a 4-storey mixed-use development across Third Street to the north with 181 dwelling units (DP1126), and single residential dwellings to the east along Watfield Avenue and to the south along Sperling Road.

Nearby amenities (and approximate distances from the site) include a recently dedicated and undeveloped park at 361 Howard Avenue (150m southeast), Nanaimo District Secondary School (200m west), the Nanaimo Aquatic Centre (300m west), Fairview Elementary School (400m north), the Nanaimo Ice Centre (450m west), and Vancouver Island University (500m southwest).



DISCUSSION

Proposed Development

The proposed development consists of two 6-storey multi-family rental residential buildings with a combined total of 171 dwelling units. The proposed unit composition is as follows:

Unit Type	Building 1	Building 2	Total	Approximate Sizes
Studio	5	16	21	35m ²
One-Bedroom	18	45	63	55m ² - 68m ²
Two-Bedroom	34	33	67	80m² - 92m²
Three-Bedroom	10	10	20	96m² - 112m²
Total	67	104	171	

The proposed gross floor area of Building 1 is 6,244m² and the proposed gross floor area of Building 2 is 8,808m², for a combined total of 15,052m². The total Floor Area Ratio (FAR) will be 1.63, which is below the maximum permitted FAR of 1.70 for this development. The base maximum FAR for the COR2 zone is 1.25 and the applicant is proposing to achieve an additional 0.25 FAR through the provision of amenities as outlined in 'Schedule D – Amenity Requirements for Additional Density' of the "City of Nanaimo Zoning Bylaw 2011 No. 4500" (the "Zoning Bylaw") and an additional 0.20 FAR by providing 80% of the required parking underground.

The applicant is proposing to meet Tier 1 in 'Schedule D' by providing amenities including the following:

- electric vehicle (EV) charging stations for 50% of all parking stalls;
- a pedestrian trail across the site for public use;
- exceeding the BC Energy Step Code by one step; and
- educational signage regarding sustainable energy management practices.

Site Design

Building 1 will be sited in the west portion of the lot, parallel with the rear property line. Building 2 will be L-shaped and sited closer to Watfield Avenue. The primary vehicular access to the site will be from a private drive aisle (via reciprocal access agreement) across 525 and 515 Third Street which will connect to Hillcrest Avenue and Watfield Avenue. This access will lead to a small surface parking lot between the two buildings and ramps to two levels of underground parking connecting both buildings. An additional surface parking lot, adjacent to Building 2, will be accessed from Watfield Avenue. All required parking will be provided on-site including 44 surface parking stalls and 172 underground parking stalls. The proposed parking is largely underground and where it is at-grade it is broken into smaller areas next to and behind buildings, in accordance with the General Development Permit Area Design Guidelines ("General Design Guidelines").

The principal entry for Building 2 will face Watfield Avenue, accessed by a staircase and ramp due to a grade change. A concrete pedestrian path along the north side of Building 2 will connect Watfield Avenue to the principal entry for Building 1 in the interior of the site. An additional future pedestrian connection will be secured from Third Street across 515 Third Street. A public pedestrian trail along the south property line with a minimum width of 2.0m will be secured by a Statutory Right-of-Way (SRW) for a future anticipated connection to Hillcrest Avenue. Private pedestrian connections between the SRW and both buildings are proposed.



Outdoor amenity areas include a patio and children's play area to the south of Building 1, and a rooftop amenity space on the fourth floor of Building 2. Dark-sky compliant bollard lighting is proposed throughout the site along walkways and around amenity spaces. A refuse room is proposed in Building 2 that will open towards the parking lot between both buildings. Short-term bicycle parking is proposed outside of the entries for both buildings, and long-term bicycle parking with a bike repair station is proposed in the lower underground parking level.

Building Design

The proposed buildings are contemporary in design with architectural elements expressing the residential use. Both buildings will feature a rhythm of massing created by framed blocks and recesses to break up the horizontal roofline. The proposed building heights are between 14.0m and 14.3m, below the maximum building height of 18.0m permitted in the COR2 zone for a development with underground parking.

Building 1 (the west building) is 6-storeys in height except for the southernmost portion where it is stepped down to 5-storeys. This building is sited at a 45 degree angle away from the south property line to maximize building separation from neighbouring single residential dwelling properties to the south and 3-storey townhouses to the west. Building 2 (the east building) is 5-storeys in height except on the west elevation, facing the internal parking are, where it presents a 6-storey elevation with the exposed upper parking level. The L-shaped building steps down to 4-storeys on its south wing to reduce overlook to neighbouring properties. The buildings are set back more than 6m from the south side lot line and have minimal openings or balconies facing lower density neighbours, as recommended by the Harewood Neighbourhood Plan Urban Design Framework and Guidelines (the "Harewood Urban Design Guidelines"). All units will include outdoor balconies or patios.

Exterior building materials will consist of different shades of smooth cementitious panel, wood-like lap siding, and manufactured stone cladding. The material palette will be accented by aluminum framed ground-level windows, aluminum railings, and white soffits. The principal entry lobbies of both buildings will be highlighted by two-storey-high windows. Indoor amenity spaces for residents are proposed in both buildings, in addition to the outdoor amenity areas.

Landscape Design

The proposed landscape design distributes planting throughout the site including at the Building 2 entry facing Watfield Avenue, along the public walkway, at the drive aisle entry to the central parking lot, and to the west of Building 1 alongside a stormwater detention area. Trees proposed on-site include a mix of evergreen and deciduous species, with some ornamental types. Along the south property line, a wood fence and low hedge interspersed with Beech trees will provide a screen for the public walkway. Climbing vines (Virginia creeper) are proposed along the south elevations of both buildings to soften views from adjacent rear yards.

The rooftop amenity space on Building 2 will include planter boxes along the southern edge to provide screening and mitigate overlook impacts on adjacent properties. Feature ornamental boulders are proposed to highlight the vehicle entry on Watfield Avenue. Retaining walls will be used to manage grade changes to the west of Building 1 and to the south of Building 2.



Design Advisory Panel

The Design Advisory Panel (DAP), at its meeting held on 2022-JUL-28, accepted DP1275 as presented and provided eight recommendations. The applicant subsequently responded to the DAP recommendations on 2023-JUL-26 as outlined below.

DAP Recommendation	Applicant Response
Consider adding canopies over the	The main entries for both buildings have been
main entrances of both building.	revised to include 1.2m overhangs.
Consider ways to cover all upper	The uppermost balconies have been revised to
floor balconies.	include 1.2m overhangs.
Consider ways to increase outdoor	The outdoor amenity area between the buildings
amenity space.	has been expanded by relocating the refuse
	enclosure to the upper parking level.
Consider stepping back the height	Building 1 originally had a 6-storey massing for
of Building 1 on the southwest	its entire length, and the building design has
corner, in keeping with the	been revised to step down to 5-storeys closest to
neighbourhood plan.	the south property line.
Consider increasing the density of	The applicant and landscape architect reviewed
trees to mitigate the hard surfaces,	options for the landscape buffer and determined
and add more trees along the	that the shrub hedge with interspersed trees was
pedestrian walkway.	best suited for the site.
Consider ways to reduce hard	More plant materials have been added to the
surfaces by adding more plant	interior of the site with the relocation of the
material.	refuse enclosure.
Consider an alternate material for	The applicant considered alternate options for
the play area surface.	the playground but ultimately decided that a
	rubberized surfacing was best suited for the site.
Consider moving garbage to the	The refuse area has been relocated indoors.
garage.	

Staff have accepted the applicant's response to the DAP recommendations, and are of the opinion that the proposed development is in substantial compliance with the applicable General Design Guidelines and the Harewood Urban Design Guidelines. No variances are requested.

SUMMARY POINTS

- Development Permit Application No. DP1275 is for a multi-family residential development with two buildings and a combined total of 171 dwelling units at 325 Watfield Avenue.
- The proposed development is in substantial compliance with the applicable General Development Permit Area Design Guidelines and the Harewood Urban Design Guidelines.
- No variances are requested.



ATTACHMENTS

ATTACHMENT A: Permit Conditions
ATTACHMENT B: Subject Property Map
ATTACHMENT C: Site and Parking Plans

ATTACHMENT D: Building Elevations and Details

ATTACHMENT E: Building Renderings

ATTACHMENT F: Site Sections ATTACHMENT G: Shadow Study

ATTACHMENT H: Landscape Plan and Details

ATTACHMENT I: Schedule D – Amenity Requirements for Additional Density

Submitted by: Concurrence by:

Lainya Rowett Jeremy Holm


Manager, Current Planning Director, Planning & Development

ATTACHMENT A PERMIT CONDITIONS

CONDITIONS OF PERMIT

- 1. The subject property is developed in substantial accordance with the Site and Parking Plans prepared by RJSG Architect, dated 2023-NOV-07 as shown on Attachment C.
- 2. The development is in substantial compliance with the Building Elevations and Details prepared by RJSG Architect, dated 2023-NOV-07, as shown on Attachment D.
- 3. The development is in substantial compliance with the Site Sections prepared by RJSG Architect, dated 2023-NOV-07, as shown on Attachment F.
- 4. The development is in substantial compliance with the Landscape Plan and Details prepared by Lazzarin Svisdahl Landscape Architects, dated 2023-JUL-07 and 2023-NOV-29, as shown on Attachment H.
- 5. The subject property is developed in accordance with the 'Schedule D Amenity Requirements for Additional Density' prepared Ironclad Developments Inc., received 2022-JUN-02, as shown in Attachment I, and to include the following items:
 - A letter from the coordinating professional submitted prior to building permit issuance outlining how the required items for additional density will be achieved; and
 - A letter from the coordinating professional with accompanying evidence submitted prior to building occupancy demonstrating that the required items have been provided.
- 6. Registration of a Statutory Right-of-Way with an approximate width of 3.0m, prior to building occupancy, for a 2.0m-wide public walkway along the south property line generally as shown on Attachment C.


ATTACHMENT B SUBJECT PROPERTY MAP

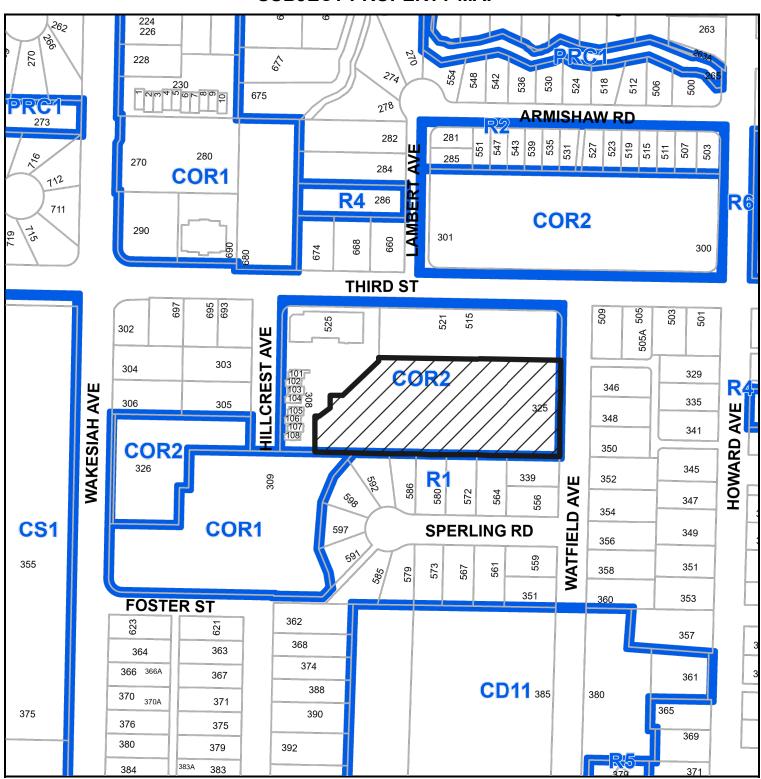


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325 Watfield Ave.

ATTACHMENT C SITE AND PARKING PLANS



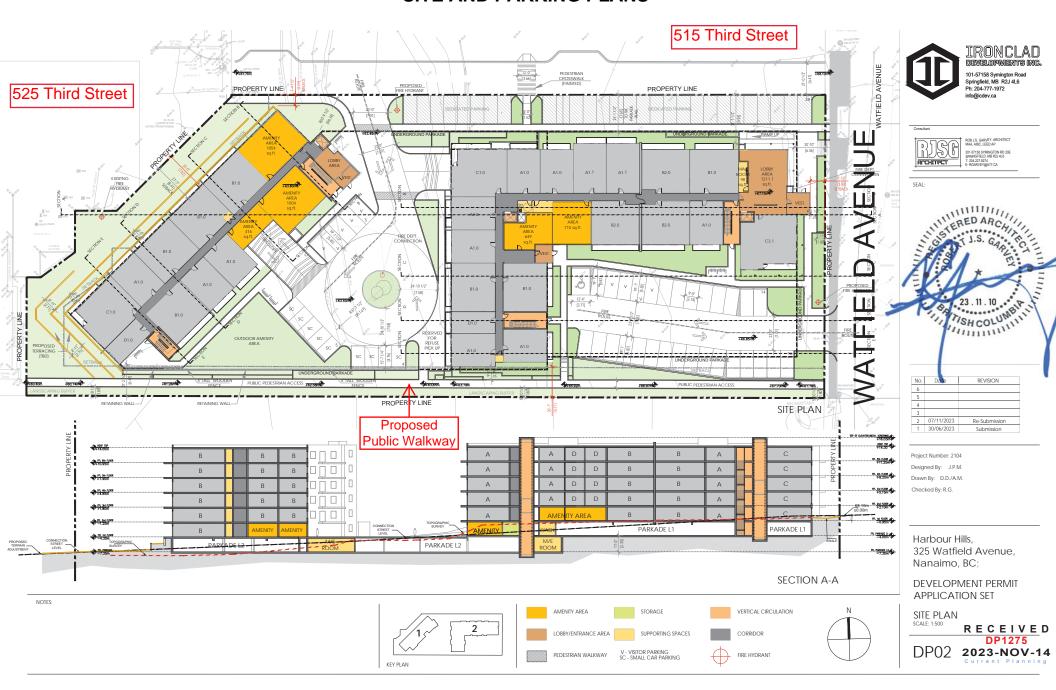

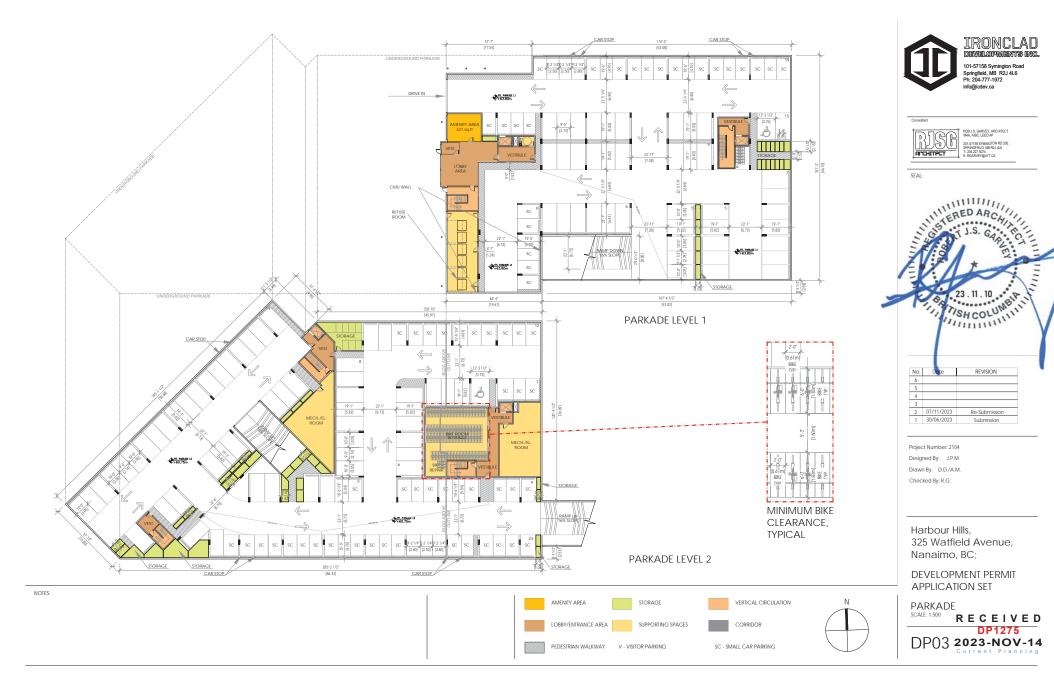ATTACHMENT D BUILDING ELEVATIONS AND DETAILS








NOTES:

STAIRWELL WINDOWS WILL HAVE AN INTERNAL GUARDRAIL AT 42' AFF

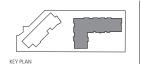

LEGEND

- (A) JAMES HARDIE, PANEL, SMOOTH ARCTIC WHITE
- B JAMES HARDIE, PANEL, SMOOTH LIGHT MIST
- O JAMES HARDIE, PANEL, SMOOTH GRAY SLATE

CHRIS CRAFT (CUSTOM PAINT)

- D JAMES HARDIE, PANEL, SMOOTH NIGHT GRAY
- F JAMES HARDIE, PANEL, SMOOTH MIDNIGHT BLACK (3) HARDIE LAP SIDING- CEDARMILL-FISCHER 2.0
- ⊕ HARDIE LAP SIDING- MONTEREY TAUPE
- ① PVC FRAMED WINDOWS WITH CLEAR GLASS (COLOR TO MATCH ELEVATIONS)
- ALUMINUM STORE FRONT- BLACK FRAME WITH CLEAR GLASS (COLOR TO MATCH ELEVATION)
- (S) ALUMINUM PICKET RAILING -BLACK
- © ELDORADO STONE, MANUFACTURED STONE, NICKEL ZEN24 (PLEASE REFER TO IXL WEBSITE FOR DETAILS)
- (N) SOFFITS, FACIA AND GUTTER- ARCTIC WHITE
- (N) 6" ROUND STRUCTURAL COLUMN- COLOR, REFER TO ELEVATIONS
- CAST IN PLACE CONCRETE





201-57158 SYMINGTON RD 20E SPRINGFIELD, MB R2J 4L6 T: 204.227.9274 E: RGARVEY@A77.CA



No.	Date	REVISION
6		
5		
4		
3		
2	07/11/2023	Re-Submission
1	30/06/2023	Submission

Project Number: 2104 Designed By: J.P.M. Drawn By: D.D./A.M. Checked By: R.G.

Harbour Hills. 325 Watfield Avenue, Nanaimo, BC;

DEVELOPMENT PERMIT APPLICATION SET

BUILDING 2- ELEVATIONS

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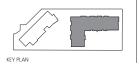
DP11 2023-NOV-14





NOTES:

STAIRWELL WINDOWS WILL HAVE AN INTERNAL GUARDRAIL AT 42' AFF



LEGEND

- A JAMES HARDIE, PANEL, SMOOTH ARCTIC WHITE
- B JAMES HARDIE, PANEL, SMOOTH LIGHT MIST O JAMES HARDIE, PANEL, SMOOTH - GRAY SLATE
- D JAMES HARDIE, PANEL, SMOOTH NIGHT GRAY
- () JAMES HARDIE, PANEL, SMOOTH IRON GRAY
- (F) JAMES HARDIE, PANEL, SMOOTH MIDNIGHT BLACK (S) HARDIE LAP SIDING- CEDARMILL-FISCHER 2.0 CHRIS CRAFT (CUSTOM PAINT)
- HARDIE LAP SIDING- MONTEREY TAUPE
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- ELDORADO STONE, MANUFACTURED STONE, NICKEL ZEN24 (PLEASE REFER TO IXL WEBSITE FOR DETAILS)
- N SOFFITS, FACIA AND GUTTER- ARCTIC WHITE
- (N) 6" ROUND STRUCTURAL COLUMN- COLOR, REFER TO ELEVATIONS
- CAST IN PLACE CONCRETE





ROB J.S. GARVEY, ARCHITECT MAA, AIBC, LEED AP 201-57158 SYMINGTON RD 20E SPRINGFIELD, MB R2J 4L6 T: 204-227-9274 E: RGARVEY@A77.CA



No.	Date	REVISION
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1	30/06/2023	Submission

Project Number: 2104 Designed By: J.P.M. Drawn By: D.D./A.M. Checked By: R.G.


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BUILDING 2- ELEVATIONS

RECEIVED DP1275

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Project Number: 2104 Designed By: J.P.M. Drawn By: D.D./A.M./G.P. Checked By: R.G.

Harbour Hills, 325 Watfield Avenue, Nanaimo, BC;

DEVELOPMENT PERMIT APPLICATION SET

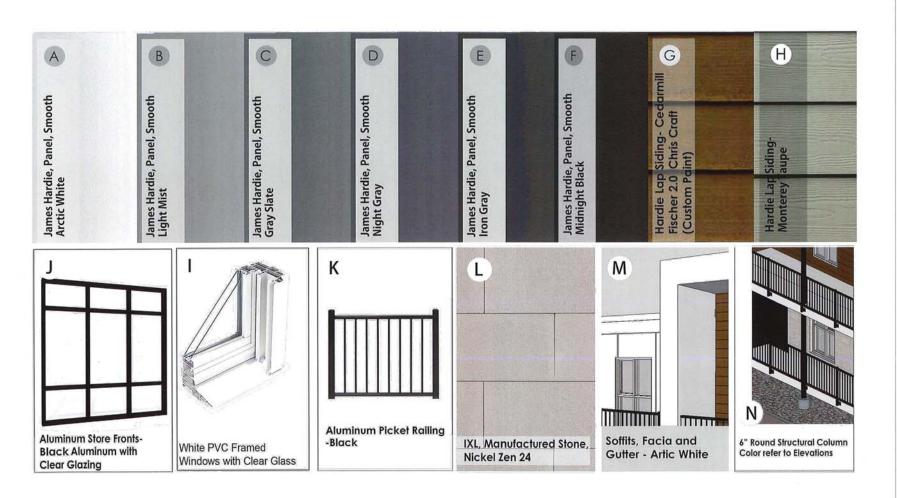MATERIALS

RECEIVED **DP1275**

DP13 2023-JUL-26

LEGEND

- (A) JAMES HARDIE, PANEL, SMOOTH ARCTIC WHITE
- (B) JAMES HARDIE, PANEL, SMOOTH LIGHT MIST C JAMES HARDIE, PANEL, SMOOTH - GRAY SLATE
- D. JAMES HARDIE, PANEL, SMOOTH NIGHT GRAY
- E) JAMES HARDIE, PANEL, SMOOTH IRON GRAY (F) JAMES HARDIE, PANEL, SMOOTH - MIDNIGHT BLACK
- G HARDIE LAP SIDING- CEDARMILL-FISCHER 2.0
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- (R) ALUMINUM PICKET BAILING -BLACK
- (I) ELDORADO STONE, MANUFACTURED STONE, NICKEL ZEN24
- (PLEASE REFER TO IXI, WEBSITE FOR DETAILS) M SOFFITS, FACIA AND GUTTER- ARCTIC WHITE
- (R 6" ROUND STRUCTURAL COLUMN- COLOR, REFER TO ELEVATIONS

ATTACHMENT E BUILDING RENDERINGS





ROB JS. GARVEY, ARCHITECT MAA, ARB., LEED AP 201-57158 SYMNOSTON RD 2015 SPRINGSTREID, MB R2J 4L6 T: 201-221 2924 E: RIGHRYEY/BATT.CA

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1	30/06/2023	Submission

Project Number: 2104 Designed By: J.P.M. Drawn By: D.D./A.M. Checked By: R.G.

Harbour Hills, 325 Watfield Avenue, Nanaimo, BC;

DEVELOPMENT PERMIT APPLICATION SET

ARTISTIC RENDERING

RECEIVED DP1275 DP16 2023-NOV-14















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2	07/11/2023	Re-Submission
1	30/06/2023	Submission

Project Number: 2104 Designed By: J.P.M. Drawn By: D.D./A.M. Checked By: R.G.

Harbour Hills, 325 Watfield Avenue, Nanaimo, BC;

DEVELOPMENT PERMIT APPLICATION SET

ARTISTIC RENDERING

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	1	30/06/2023	Submission

Project Number: 2104 Designed By: J.P.M. Drawn By: D.D./A.M. Checked By: R.G.

Harbour Hills, 325 Watfield Avenue, Nanaimo, BC;

DEVELOPMENT PERMIT APPLICATION SET

ARTISTIC RENDERING

RECEIVED DP1275 DP18 2023-NOV-14













ROB J.S. GARVEY, ARCHITECT MAA, AIBC, LEED AP





Project Number: 2104 Designed By: J.P.M. Drawn By: D.D./A.M. Checked By: R.G.

Harbour Hills, 325 Watfield Avenue, Nanaimo, BC;

DEVELOPMENT PERMIT APPLICATION SET

ARTISTIC RENDERING

RECEIVED DP1275

DP19 2023-NOV-14











ROB J.S. GARVEY, ARCHITECT MAA, ABG., LEED AP 201-57158 SYMINGTON RD 2015 SPRINGSPIELD, MB R2J 4L 6 T: 204 227 2974 E: RIGHRYEY/GRATZON



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2	07/11/2023	Re-Submission
1	30/06/2023	Submission

Project Number: 2104 Designed By: J.P.M. Drawn By: D.D./A.M. Checked By: R.G.

Harbour Hills, 325 Watfield Avenue, Nanaimo, BC;


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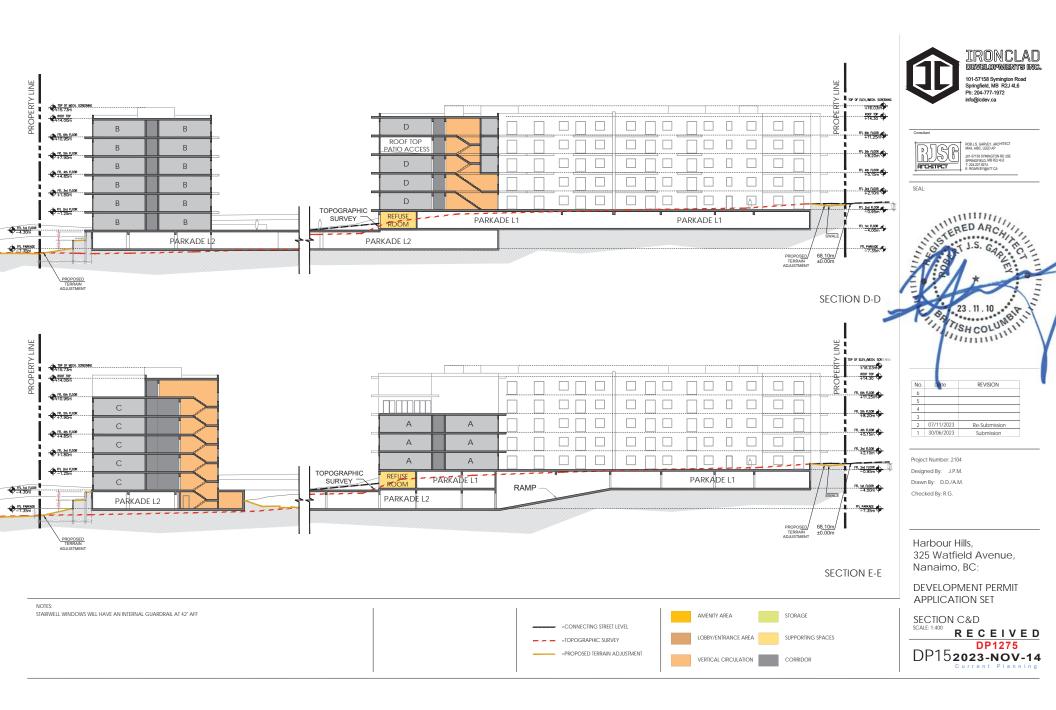
ARTISTIC RENDERING

RECEIVED DP1275 DP20 2023-NOV-14



ATTACHMENT F SITE SECTIONS



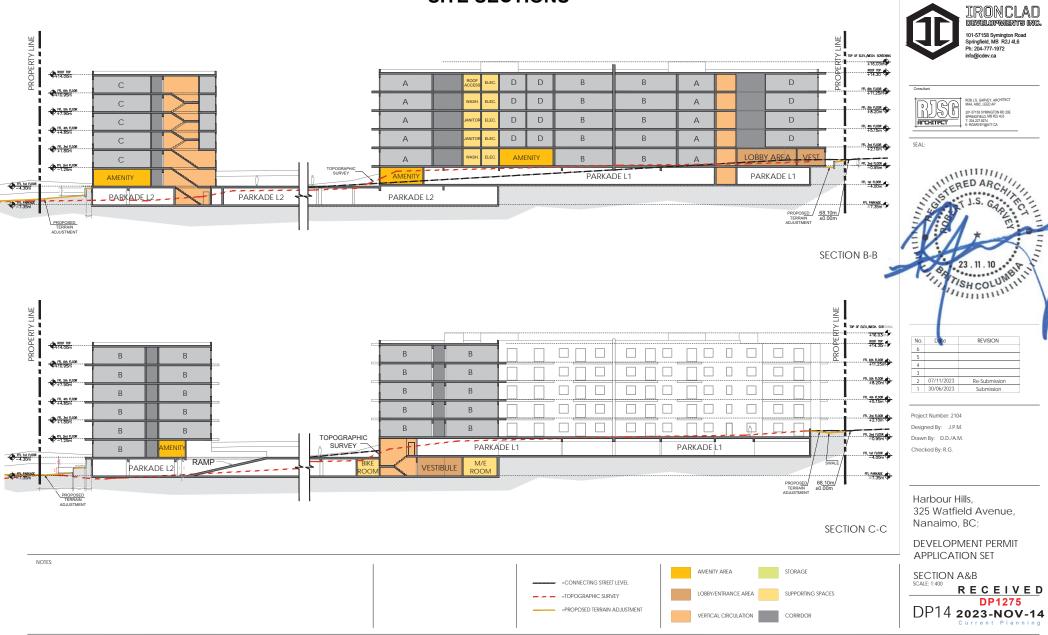

ATTACHMENT G SHADOW STUDY



UTC -08:00 Harbour Hills, Nanaimo, BC; 20th March 09AM



UTC -08:00 Harbour Hills, Nanaimo, BC; 20th March 12PM



UTC -08:00 Harbour Hills, Nanaimo, BC; 20th March 03PM



UTC -08:00 Harbour Hills, Nanaimo, BC; 21st June 12PM



UTC -08:00 Harbour Hills, Nanaimo, BC; 21st June 03PM

UTC -08:00 Harbour Hills, Nanaimo, BC; 21st June 09AM

NOTES:

Harbour Hills,
325 Watfield Avenue,
Nanaimo, BC;
DEVELOPMENT PERMIT
APPLICATION SET
SHADOW STUDY

RECEIVED
DP1275
DP232023-NOV-14

STISH COLUMBIA

REVISION

101-57158 Symington Road Springfield, MB R2J 4L6 Ph: 204-777-1972 info@icdev.ca

ACCHITECT



UTC -08:00 Harbour Hills, Nanaimo, BC; 22nd September 09AM



UTC -08:00 Harbour Hills, Nanaimo, BC; 22nd September 12PM



UTC -08:00 Harbour Hills, Nanaimo, BC; 22nd September 03PM



UTC -08:00 Harbour Hills, Nanaimo, BC; 21st December 12PM



UTC -08:00 Harbour Hills, Nanaimo, BC; 21st December 03PM

UTC -08:00 Harbour Hills, Nanaimo, BC; 21st December 09AM

NOTES:

Harbour Hills, 325 Watfield Avenue, Nanaimo, BC; DEVELOPMENT PERMIT APPLICATION SET

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DP242023-NOV-14

SHADOW STUDY SCALE: N.T.S.


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REVISION

101-57158 Symington Road Springfield, MB R2J 4L6 Ph: 204-777-1972 info@icdev.ca

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ATTACHMENT H LANDSCAPE PLAN AND DETAILS





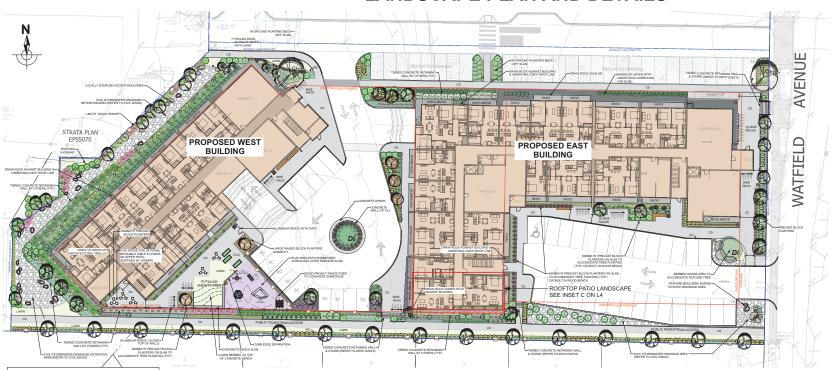



CHILDRENS PLAY EQUIPMENT POSSIBLE SUPPLIER: HABITAT SYSTEMS INC. 1 866 422 4828

Date	Revisions	Ву
April 12, 2022	Preliminary Draft For Review	LS/SD
July 7, 2023	Issue for DP	LS/SS



SELUX INULA BOLLARD
OR APPROVED EQUIVALENT
LED DARK SKY COMPLIANT BOLLARD
COLOUR-BLACK
HT: 3.5' (1 METER)

Project

Harbour Hills 525 Third Street Nanaimo, BC

Sheet Title

Overall Landscape Plan

Date April 12, 2022

Scale 1:250 METERS

Project No.

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Drawing No.

2023-JUL-26

OVERALL PROJECT PLANT LIST

Lf Athyrium filix-femina

UTIMEDUL	DO TATIONE HAME	COMMON NAME	000.41	UILL
	Trees			
Am	Acer ginnala	Amur Maple	5	6cm Cal.
Dm	Acer glabrum	Douglas Maple	10	#5pot
Ps	Pinus contorta v.contorta	Shore Pine	6	#5pot
Cn	Cornus nuttallii x florida (Eddies White Wonder)		4	6cm Cal.
Fs	Fagus sylvatica 'Dawyck Purple'	Dawyck Purple Beech	22	6cm Cal.
Di	Davidia involucrata	Dove Tree	2	6 cm Cal
Gh	Ginkgo biloba 'Princeton Sentry'	Princeton Sentry Ginkgo	2	6cm Cal.
Psc	Prunus sargentii 'Columnaris'	Columnar Sargent Cherry	1 7	6cm Cal.
PpH	Picea pungens 'Hoopsi'	Hoopsii Spruce	6	2m
	Picea pungens Hoopsii	Hoopsii Spruce	_	
	Shrubs		1	
Bc.	Berberis thunbergii 'Concorde'	Concorde Barberry	54	#2pot
Brn	Berberis thunbergii 'Rose Glow'	Rose Glow Barberry	44	#2pot
CaK	Cornus sericea 'Kelsevi'	Dwarf Kelsey Dogwood	96	#2pot
ih	Juniperus communis 'Effusa'	Common Juniper (horizontal form)	87	#2pot
L	Lonicera ciliosa	Trumpet Honevsuckle	24	#2pot
La	Ledum groenlandicum	Labrador Tea	26	#2pot
Mr	Mahonia repens	Creeping Oregon Grape	87	#2pot
Pv		Mock Orange	3	#2pot
	Philadelphus x virginalis		97	
pvs	Philadelphus x virginalis 'Dwarf Snowflake'	Miniature Snowflake Mock Orange		#2pot
Ra	Ribes alpinum	Alpine Currant Pacific Rhododendron	10	#2pot
Rhc	Rhododendron macrophyllum		13	#2pot
Rr	Rhododendron x 'Ramapo'	Ramapo Rhododendron	23	#2pot
RR	Rosa 'Noamel'	Flower Carpet Appleblossem Rose	10 64	#2pot
Rn Sc	Rosa nutkana Sarcococca confusa	Nootka Rose Sweet Box	40	#2pot
Si	Skimmia iaponica 'Rubella'	Compact Skimmia	63	#2pot
St.	Sorbaria sorbifolia	False Soirea	63	#2pot
Sr	Sorbaria sorbifolia 'Sem'	Femleaf False Spirea	63	#2pot
Sb	Symphoricarpos albus	Snowberry	7	#2pot
Saf	Spiraea x bumalda 'Goldflame'	Goldflame Spirea	127	#2pot
VI	Viburnum trilobum	Highbush Cranberry	16	#2pot
	Tibumum mobum	rigitadan oranbony	10	#ZpOt
	Ornamental Grasses, Vines & Groundcover			
Ck	Calamagrostis x acutifolia 'Karl Foerster'	Feather Reed Grass	246	#1pot
Dc	Deschampia cespitosa	Tufted Hairgrass	134	#1pot
Н	Helictotrichon sempervirens	Blue Oat Grass	111	#1pot
Ph	Pennisetum alopecuroides 'Hameln'	Dwarf Fountain Grass	71	#1pot
Q	Parthenocissus Quinquefolia	Virginia Creeper	24	#1pot
k	Arctostaphyllos uva-ursi	Kinnickinnick	71	10cm pot
VV	Vaccinium vitis idea	Lingonberry	31	#1pot
	Perennials			
Ap	Adiantum pedatum	Maidenhair Fern	10	#1pot
a	Allium cernuum	Nodding Onion	60	#1pot
h	Heuchera micrantha 'Bressingham Bronze'	Bressingham Bronze Croal Bells	23	#1pot
	recorded increment orestingially brotize	brownighten bronze crost bells	- 23	= ipot

COMMON NAME COUNT SIZE

PROPOSED TREE EXAMPLE IMAGES















. PLANT MATERIAL AND CONSTRUCTION METHODS WORK AND MATERIALS SHALL MEET OR EXCEED THE CANADIAN	LANDSCAPE STANDARDS

ALL PLANTING BEDS SHALL BE WATERED BY AUTOMATIC IRRIGATION SYSTEM

3. TURF AREAS FROM SOD SHALL BE NO. I GRADE GROWN FROM CERTIFIED SEED AND SHALL BE TOLERANT OF DROUGHT CONDITIONS. A MINIMUM OF 150 MM DEPTH OF GROWING MEDIUM IS REQUIRED BENEATH TURF AREAS, TURF AREAS SHALL MEET EXISTING GRADES AND BE FLUSH TO ADJACENT HARD SURFACES.

4. REFER TO CIVIL ENG. DWGS FOR SITE GRADING AND DRAINAGE AND WILL ENSURE THAT NO WATER OR LOOSE IMPEDIMENTS WILL BE DISCHARGED FROM THE LOT ONTO ADJACENT PUBLIC, COMMON, OR PRIVATE PROPERTIES.

_	LED DARK SKY COMPLIANT BOLLARD LIGH COLOUR:BLACK HT: 3.5' (1 METER)
	,

SELUX INULA BOLLARD
OR APPROVED EQUIVALENT

LEGEND

CS

PROPERTY LINES

DRAIN ROCK 200 MM DEPTH 2" - 4" DIM WASHED COBBLE ROCK ON FILTER FABRIC CW PT WOOD EDGER.

LAWN = SOD ON 150 MM MIN DEPTH APPROVED GROWING MEDIUM

FORMAL PLANTING BED CW 60 MM OF FIR BARK MULCH GROUNDCOVER ON FILTER FABRIC ON APPROVED GROWING MEDIUM. 450 MM MIN DEPTH FOR SHRUBS 700 MM MIN FOR TREES

COMPOST MULCH NO FILTER FABRIC ON APPROVED GROWING MEDIUM. 450 MM MIN DEPTH FOR SHRUBS 700 MM MIN FOR TREES

1 200 MM HT. METAL FENCE & GATE (PLAY AREA) COLOUR / STYE TO MATCH RAILING AT TOP OF CONCRETE WALLS

BENCH FIXED TO CONCRETE SURFACE


DERO ROLLING BIKE RACK SECURED TO CONCRETE WALKWAY (OR APPROVED EQUIVALENT)


GARRAGE RIN

CONCRETE CURB EDGING CONCRETE PLANTER WALLS POUR IN PLACE OR ALTERNATIVELY PRECAST CONCRETE BLOCKS STACKED TIMBER RAISED PLANTER OPEN FOR SEASONAL PLANTING

CIVIL STORMWATER DRAINAGE/ DETENTION AREA (REFER TO COLL DWG AMENTIY PLAYGROUND SPACE WITH HABITAT NATURAL PLAY ELEMENTS ON POUR-IN-PLACE RUBBER FALL SURFACING

5 #1pot

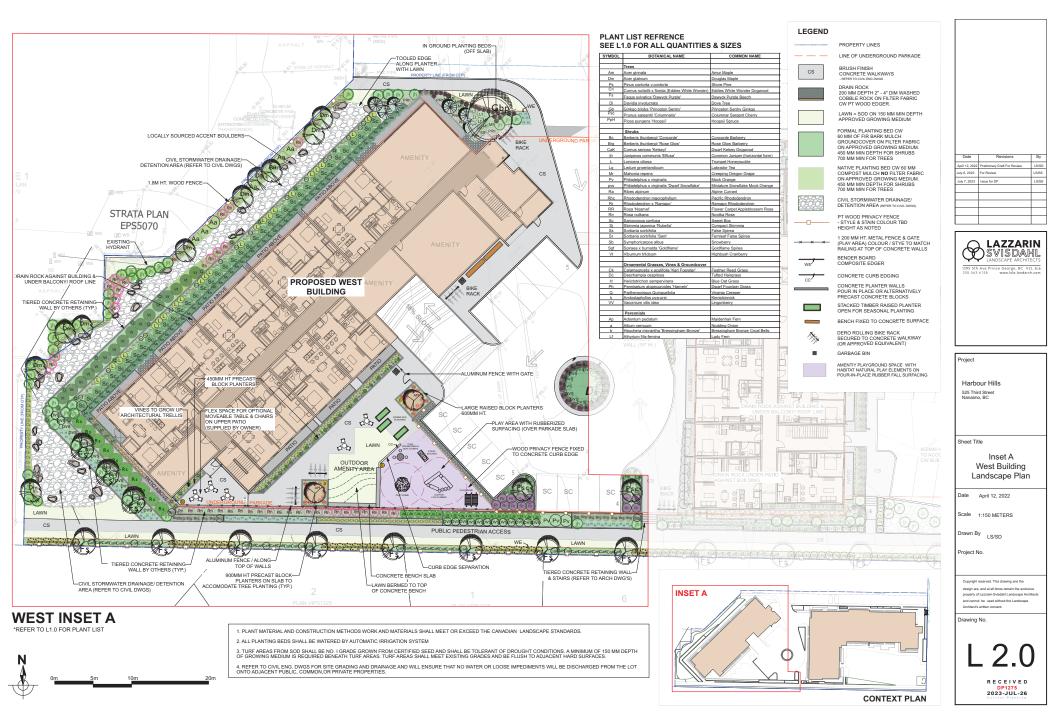

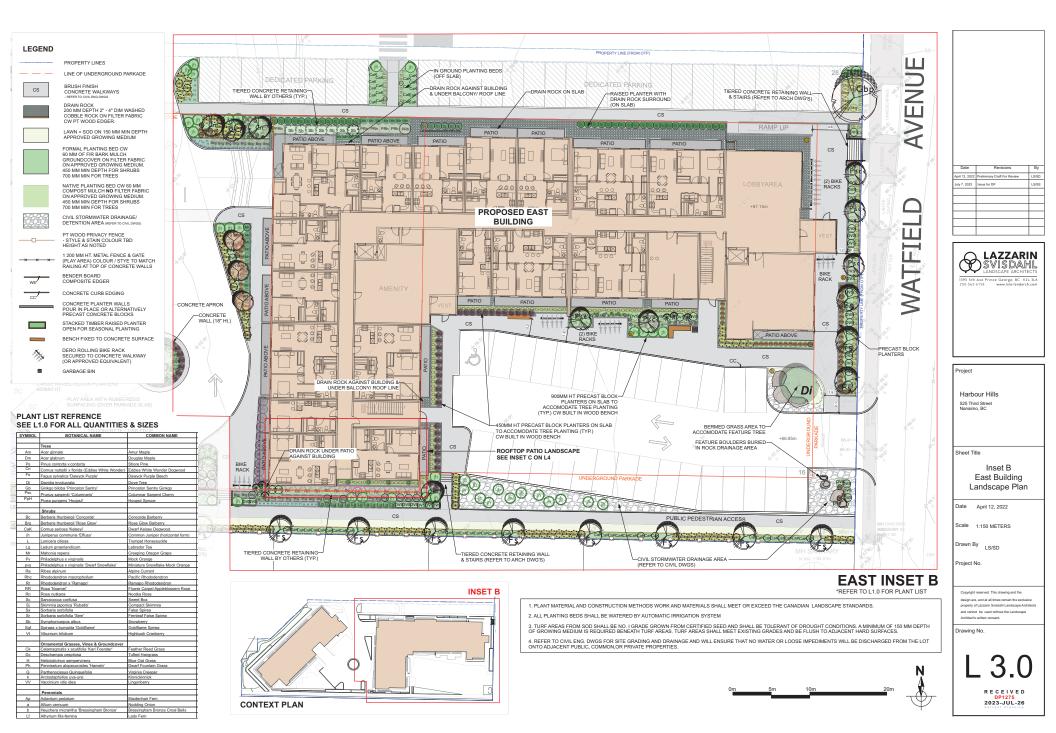



ATTACHMENT I SCHEDULE D – AMENITY REQUIREMENTS FOR ADDITIONAL DENSITY

Category 1: Site Selection (10 points required)

	Amenity	Points
Α	The proposed development is located on a brownfield site.	5
В	The proposed development is located on an existing street where the location does not require any new infrastructure such as storms drains, curbs or sidewalks.	3
С	The proposed development is located within 200m of a park or trail network.	1
D	The proposed development is located within 400m of any of the following: • retail store; • daycare facility; • Nanaimo Regional District transit bus stop; • any PRC Zoned property; and / or • a CS-1 zoned property.	1 point each
Е	The proposed development will add any of the following amenities on the site, or immediately adjacent to the site, as part of the proposed development: • retail store or public market; • daycare facility; • Nanaimo Regional District transit bus stop; • any PRC Zoned property; • a CS-1 zoned property; and / or • public art.	1 point each
To	tal	20

Proposed?
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X
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(4 points total)
X
10

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IRONCLAD DEVELOPMENTS INC.

Category 3: Parking and Sustainable Transportation (10 points required)

	Amenity	Points
Α	For non-residential uses, long term protected bicycle storage is provided and shower and change room facilities are provided to accommodate building employees where applicable.	2
В	At least one parking space is clearly marked and designated for the exclusive use of a vehicle belonging to a car share or car co-op.	1
С	The developer purchases a new car and gifts the car to a recognized car share provider for the inclusion of a car share space on the subject property.	4
D	A minimum of 50% of the parking for the proposed development includes access to an electric vehicle charging station.	2
E	A minimum of 80% of the total parking area is located underground or in a parking structure incorporated into the design of the building.	4
F	The proposed development includes covered and designated parking spaces for a motorized scooter or plug-in for an electronic bicycle or electric scooter, or a designated motorcycle parking space to accommodate the following number of spaces: a) multiple family residential developments: 1 motorized scooter or motorcycle space per 15 dwelling units	2
G	A pedestrian network is included in the proposed development that connects the buildings on the site with the public road right-of-way and, the pedestrian network from the adjacent site to which there is access by perpetual easement or right-of-way, provided the City agrees to accept the right-of-way.	2
Н	Parking does not exceed minimum parking requirements within the City's Development Parking Regulations Bylaw.	2
Ι	The development includes signage or display(s) regarding sustainable transportation alternatives available on site or within the immediate area.	1
То	tal	20

Proposed?
X
X
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X
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10













IRONCLAD DEVELOPMENTS INC.

Category 5: Energy Management (11 points required)

	Amenity	Points
A	The proposed development meets at least the requirements of Step 2 of the BC Energy Step Code and exceeds the requirement specified in the Building Bylaw by one step.*	10*
В	The proposed development meets at least the requirements of Step 3 of the BC Energy Step Code and exceeds the requirement specified in the Building Bylaw by two steps.*	15*
С	The proposed development is considered a Part 3 within the British Columbia Building Code (BCBC) and the building meets the minimum requirements of Step 4 (Net Zero Ready) within the BC Energy Step Code; or The proposed development is considered a Part 9 within the BCBC and the building meets the minimum requirements of Step 4 or 5 within the BC Energy Step Code.*	30*
D	The development includes permanent education signage or display(s) regarding sustainable energy management practices used onsite.	1
To	tal	31

Proposed?	
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X	
X	
V	
	11

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^{*} Points will be awarded for only one of A, B, or C.