


DATE OF MEETING | April 17, 2023

AUTHORED BY | GEORGE FUJII, PLANNER, CURRENT PLANNING

SUBJECT | DEVELOPMENT PERMIT NO. DP1256 – 77 CHAPEL STREET

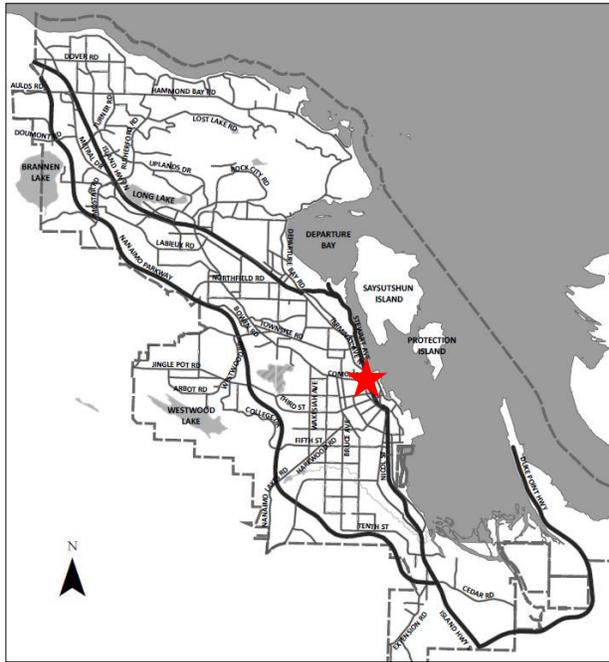

Proposal:

A 157-unit multi-family development

Current Zoning:

DT-5 Chapel Front

City Plan Land Use Designation:


Primary Urban Centre

Development Permit Areas:

- DPA8 – Form and Character
- DPA4 – Abandoned Mine Workings Hazards

Lot Area:

4,206 m²

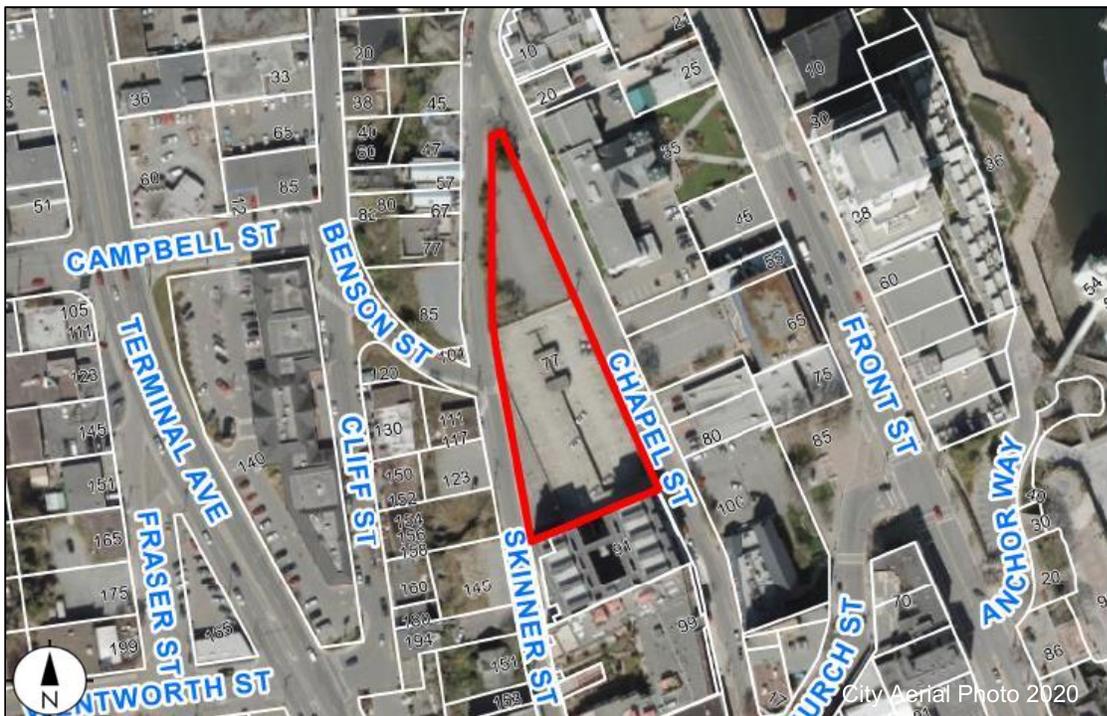

OVERVIEW

Purpose of Report

To present for Council’s consideration a development permit application for a multiple family development at 77 Chapel Street. |

Recommendation

That Council issue Development Permit No. DP1256 for a multiple family development at 77 Chapel Street with a variance as outlined in the “Proposed Variance” section of the Staff Report dated 2023-APR-17. |

BACKGROUND

A development permit application has been received from Primex Investments Ltd. on behalf of 6577 Nanaimo Holdings Ltd. to permit a multiple family development consisting of three six-storey buildings with a total of 157 units.

Subject Property and Site Context

The subject property is situated in the Chapel Front precinct of Downtown Nanaimo, located between Skinner Street and Chapel Street. The property is triangular in shape and currently contains a parkade structure which will be removed. A previous development permit, DP1117, for a 24-storey mixed-use building with 109 dwelling units and commercial space was approved for the property in 2019. The development permit subsequently expired and the property has since been sold. The site slopes downhill significantly from northeast to southwest.

The surrounding neighbourhood contains a mix of uses, including, a 24-unit mixed-use building at 10 Chapel Street to the north (completed in 2016), the Nanaimo Law Courts and offices across Chapel Street to the east, a 61-unit multi-family building at 91 Chapel Street to the south (completed in 2020), a parking lot and offices across Skinner Street to the southwest, and restaurants and residences across Skinner Street to the northwest. A number of other commercial services and amenities are available within walking distance, and Commercial Street is approximately 100m south of the subject property. |

DISCUSSION

Proposed Development

The applicant is proposing to construct three 6-storey buildings including one purpose- built rental building and two strata titled buildings, with a combined total of 157 dwelling units, as follows:

Unit Type	Building 1 – Harbour View	Building 1 – Benson View	Rental Building
Studio	1	1	12
One-Bedroom	36	15	51
Two-Bedroom	8	12	21
Total	45	28	84

The proposed total gross floor area is 11,951 m² and the total Floor Area Ratio (FAR) is 2.84, which is below the maximum FAR of 4.25 permitted under the site specific DT5 zoning of the subject property. The building floor area breakdown is as follows:

- Rental building (north) – 6,145 m²
- Strata Building (“Benson View”, southwest) – 2,241 m²
- Strata Building (“Harbour View”, southeast) - 3,565 m²

Site Design

The proposed buildings will be sited parallel to the adjacent streets, with the rental building in the north portion of the lot facing Chapel Street. One strata building (“Harbour View”) will be sited in the southeast portion of the lot facing Chapel Street, and the second strata building (“Benson View”) will face Skinner Street. A three-level underground parking structure will be shared between all three buildings. The two strata buildings will be separated by an internal private courtyard and connected by a storage space, with elevated exterior walkways on every floor.

A public plaza is proposed to the south of the rental building’s principal entry, facing Chapel Street. A gate for private access will separate the internal courtyard from the public plaza, and a private staircase will connect the internal courtyard with Skinner Street. A public art component will be incorporated into the site design on the north exterior face of the Harbour View strata building overlooking the public plaza.

Vehicle access to the underground parking is proposed from Skinner Street. A total of 165 parking stalls are proposed across three parking levels, greater than the 95 parking stalls that would be required by the City’s “Off-Street Parking Regulations Bylaw 2018 No. 7266”. All required bicycle parking (15 short-term and 79 long-term) is proposed onsite. A garbage/recycling room is provided in the underground parkade.

Building Design

The building design reflects the development’s residential use and there is a strong balance of materials on all three buildings with a distinctive base and upper levels. The massing of the strata buildings will continue the aesthetic form established by 91 Chapel Street to the south. Two-storey townhouse units are proposed on the west side of the Benson View building with individual connections to strengthen the street presence along Skinner Street and conceal the southern portion of the parking structure. The massing, form, and character of the rental building will complement the strata buildings. Private rooftop patios are proposed on the strata buildings, and a common rooftop amenity space is proposed on the rental building. All units will include either a deck or patio.

The exterior building materials will include a mix of fibre-cement panel siding and wood-like metal siding, grounded by a brick veneer at the base of the buildings. Wood-like metal soffits are proposed for the uppermost overhangs, and balconies will have aluminum guardrails. The exposed exterior of the parking levels below the rental building will be cast-in-place concrete.

The proposed design meets the intent of the City’s General Development Permit Guidelines and the Downtown Urban Design Plan and Guidelines for the Chapel Front North precinct. These include densification of the site with underground parking; continuous building presence along streets with street trees and improved public realm (plazas).

In addition to the design plans, the applicant submitted a number of technical studies in support of the application including a traffic impact assessment and servicing study which were accepted by Staff.

In addition, a geotechnical report was also provided. In accordance with the DPA4 exemption guidelines, the applicant will be required to submit further geotechnical assessment at the time of a building permit application and demolition permit, when further site investigation can be achieved, to secure any recommendations for the proposed construction in order to address potential hazards from undermining from abandoned coal mines.

Landscape Design

The landscape design reflects the urban nature of the development and includes a private courtyard at ground level between the two strata buildings with seating and a Maple tree; a public plaza facing Chapel Street with tree and shrub plantings, as well as bench seating; and a small public plaza situated at the intersection of Chapel and Skinner Streets anchored with a significant flowering tree, bench seating, and a pathway connecting the two streets.

A landscape buffer with a combination of Maple and Tupelo trees will continue along the west edge of the site abutting Skinner Street.

The landscape plan also includes a rain garden feature with a stepped waterfall feature along the north portion of the Skinner Street building façade.

Public Art

As a condition of a rezoning in 2018 of the subject property, a restrictive covenant was registered requiring the property owner to provide public art as an onsite amenity with a minimum value of \$38,000, prior to the issuance of an occupancy permit by the City. The applicant has proposed a public art budget of \$200,000 and is in the process of selecting an artist.

Through the review of the development permit application, the location for the public art has been identified as the north façade of the strata building located along Chapel Street. This location offers high visibility, accessibility and engagement opportunities for a wide audience including residents and visitors travelling along Chapel Street.

Design Advisory Panel

The Design Advisory Panel (DAP), at its meeting held on 2022-FEB-10 accepted DP1256 as presented, with support for the proposed underground parking setback variance and provided the following recommendations:

- Consider enhancing the north elevation in terms of landscape hierarchy, public art and the form and character of the north end of the rental building;
- Consider ways to soften the concrete wall on the Skinner Street elevation; and,
- Consider enhancing the south elevation of the rental building.

The applicant subsequently revised the development proposal in response to the DAP recommendations with the following changes and comments:

- The massing and character of the north side of the rental building has been adjusted through the creation of a strong “prow” which projects outwards providing a unique end to the building.
- The landscape and planting around the north end of the building has been enhanced with casual seating separating the private outdoor amenity space from the public plaza and sidewalk.
- The design of the exposed concrete parkade facing Skinner Street has been enhanced through the addition of a coloured pigment additive to provide contrast and better frame the entrance. This supplements a rain garden feature with a stepped waterfall feature which further screens this portion of the parkade.
- The same coloured concrete is provided at the parkade entry as well as a horizontal canopy and signage to identify the entry to the project on Skinner Street. Below the canopy and wrapping into the parkade entry, the concrete formed walls will be articulated with a wood board form texture. Additional landscaping is also proposed at this location to soften the parkade wall at street level.
- The south façade of the rental building has been further articulated with windows and a change of materials along a portion of the facade from fibre cement siding to wood look metal siding.

Proposed Variance

Projections Into Yards

The Zoning Bylaw requires a minimum front yard setback of 1.8m for an underground parking structure from a front lot line. The proposed parking structure setback from Chapel Street is 0.0m, a requested variance of 1.8m.

The parkade structure is proposed to be extended into the front yard setback along Chapel Street to create the appropriate width for a parking module in accordance with the City’s Off-Street Parking Bylaw. In addition, portions of the existing parking structure along Chapel Street will need to stay in place to retain stability of the street and existing services during demolition, and the new parking structure will reinforce the street as part of the new development. All buildings and structures above grade have been sited in accordance with the setback requirements of the Zoning Bylaw.

Staff support the proposed variance.

SUMMARY POINTS

- Development Permit application No. DP1256 proposes three, six-storey multi-family buildings with a combined total of 157 units.
- The site, building and landscape design meets the intent of the General Development Permit Area Design Guidelines and the Downtown Urban Design Plan and Guidelines.
- A variance is requested to reduce the minimum front yard setback from Chapel Street for an underground parking structure from 1.8m to 0.0m. Staff support the proposed setback variance.

ATTACHMENTS

ATTACHMENT A: Permit Terms and Conditions
ATTACHMENT B: Subject Property Map
ATTACHMENT C: Site and Parking Plans
ATTACHMENT D: Building Elevations and Details
ATTACHMENT E: Building Sections
ATTACHMENT F: Building Renderings
ATTACHMENT G: Landscape Plans and Details

Submitted by:

Lainya Rowett
Manager, Current Planning

Concurrence by:

Jeremy Holm
Director, Development Approvals

Dale Lindsay
General Manager, Development Services /
Deputy CAO

ATTACHMENT A

PERMIT TERMS AND CONDITIONS

PERMIT TERMS


The “City of Nanaimo Zoning Bylaw 2011 No. 4500” is varied as follows:

1. *Section 6.5.1 Projections Into Yards* – to reduce the minimum required setback for an underground parking structure from the front lot line (Chapel Street) from 1.8m to 0.0m.

CONDITIONS OF PERMIT


1. The subject property shall be developed in accordance with the Site and Parking Plans, prepared by dHK Architects, dated 2023-MAR-09, as shown on Attachment C.
2. The subject property shall be developed in substantial compliance with the Building Elevations and Details, prepared by dHK Architects, dated 2023-MAR-09, as shown on Attachment D.
3. The subject property shall be developed in substantial compliance with the Landscape Plan and Details prepared by Murdoch de Greef Inc. Landscape Planning & Design, dated 2023-FEB-23, as shown on Attachment G.
4. Registration of a Statutory Right-of-Way (SRW) prior to building occupancy for the public plaza adjacent to Chapel Street, generally as shown on Attachment C.
5. Registration of a Statutory Right-of-Way (SRW) prior to building occupancy for the public plaza and walkway at the corner of Chapel Street and Skinner Street, generally as shown on Attachment C.
6. Registration of a Statutory Right-of-Way (SRW) prior to building occupancy to achieve a 3.0m wide sidewalk from the ultimate curb along the Chapel Street frontage, generally as shown on Attachment C.

ATTACHMENT B
SUBJECT PROPERTY MAP

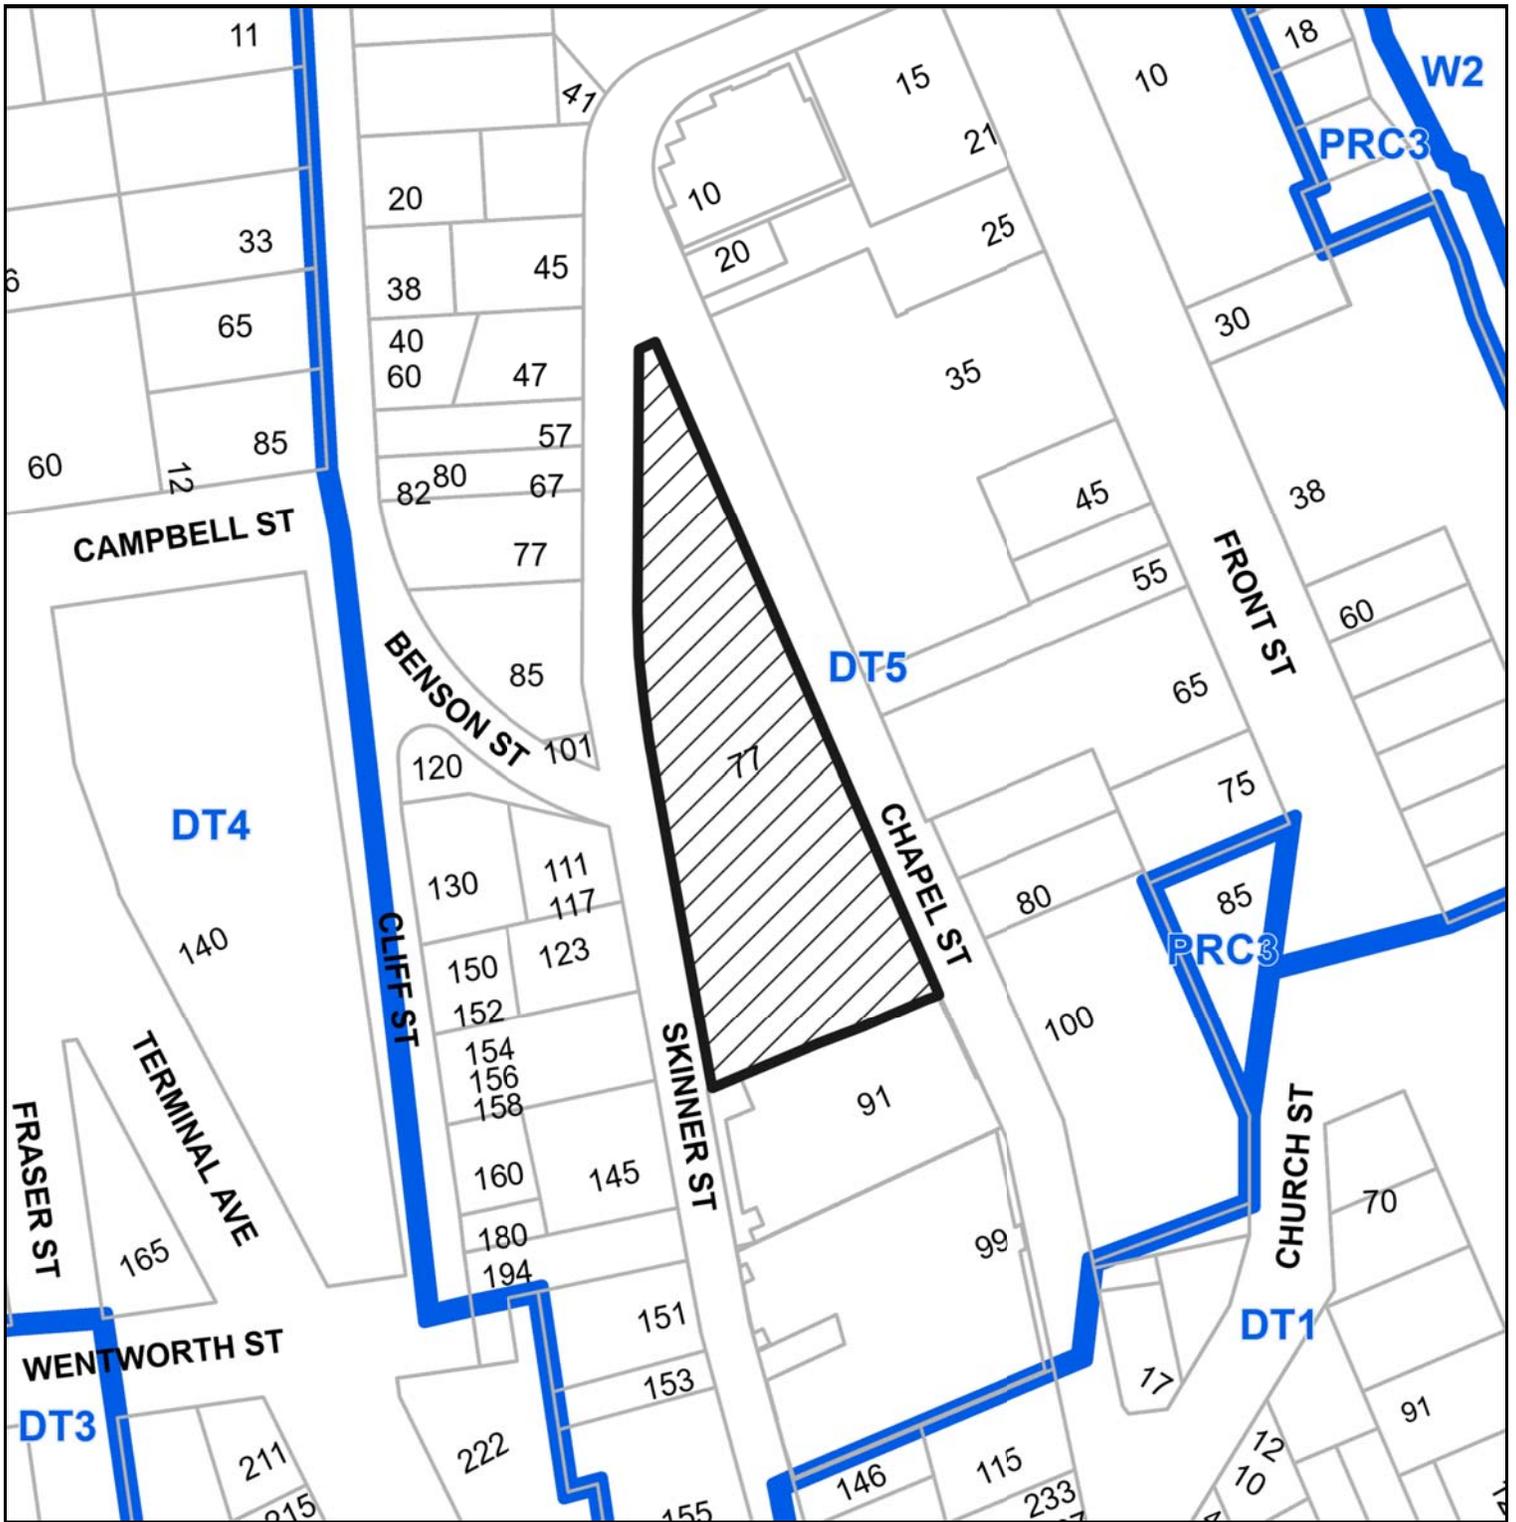


 77 CHAPEL STREET

ATTACHMENT C SITE AND PARKING PLAN

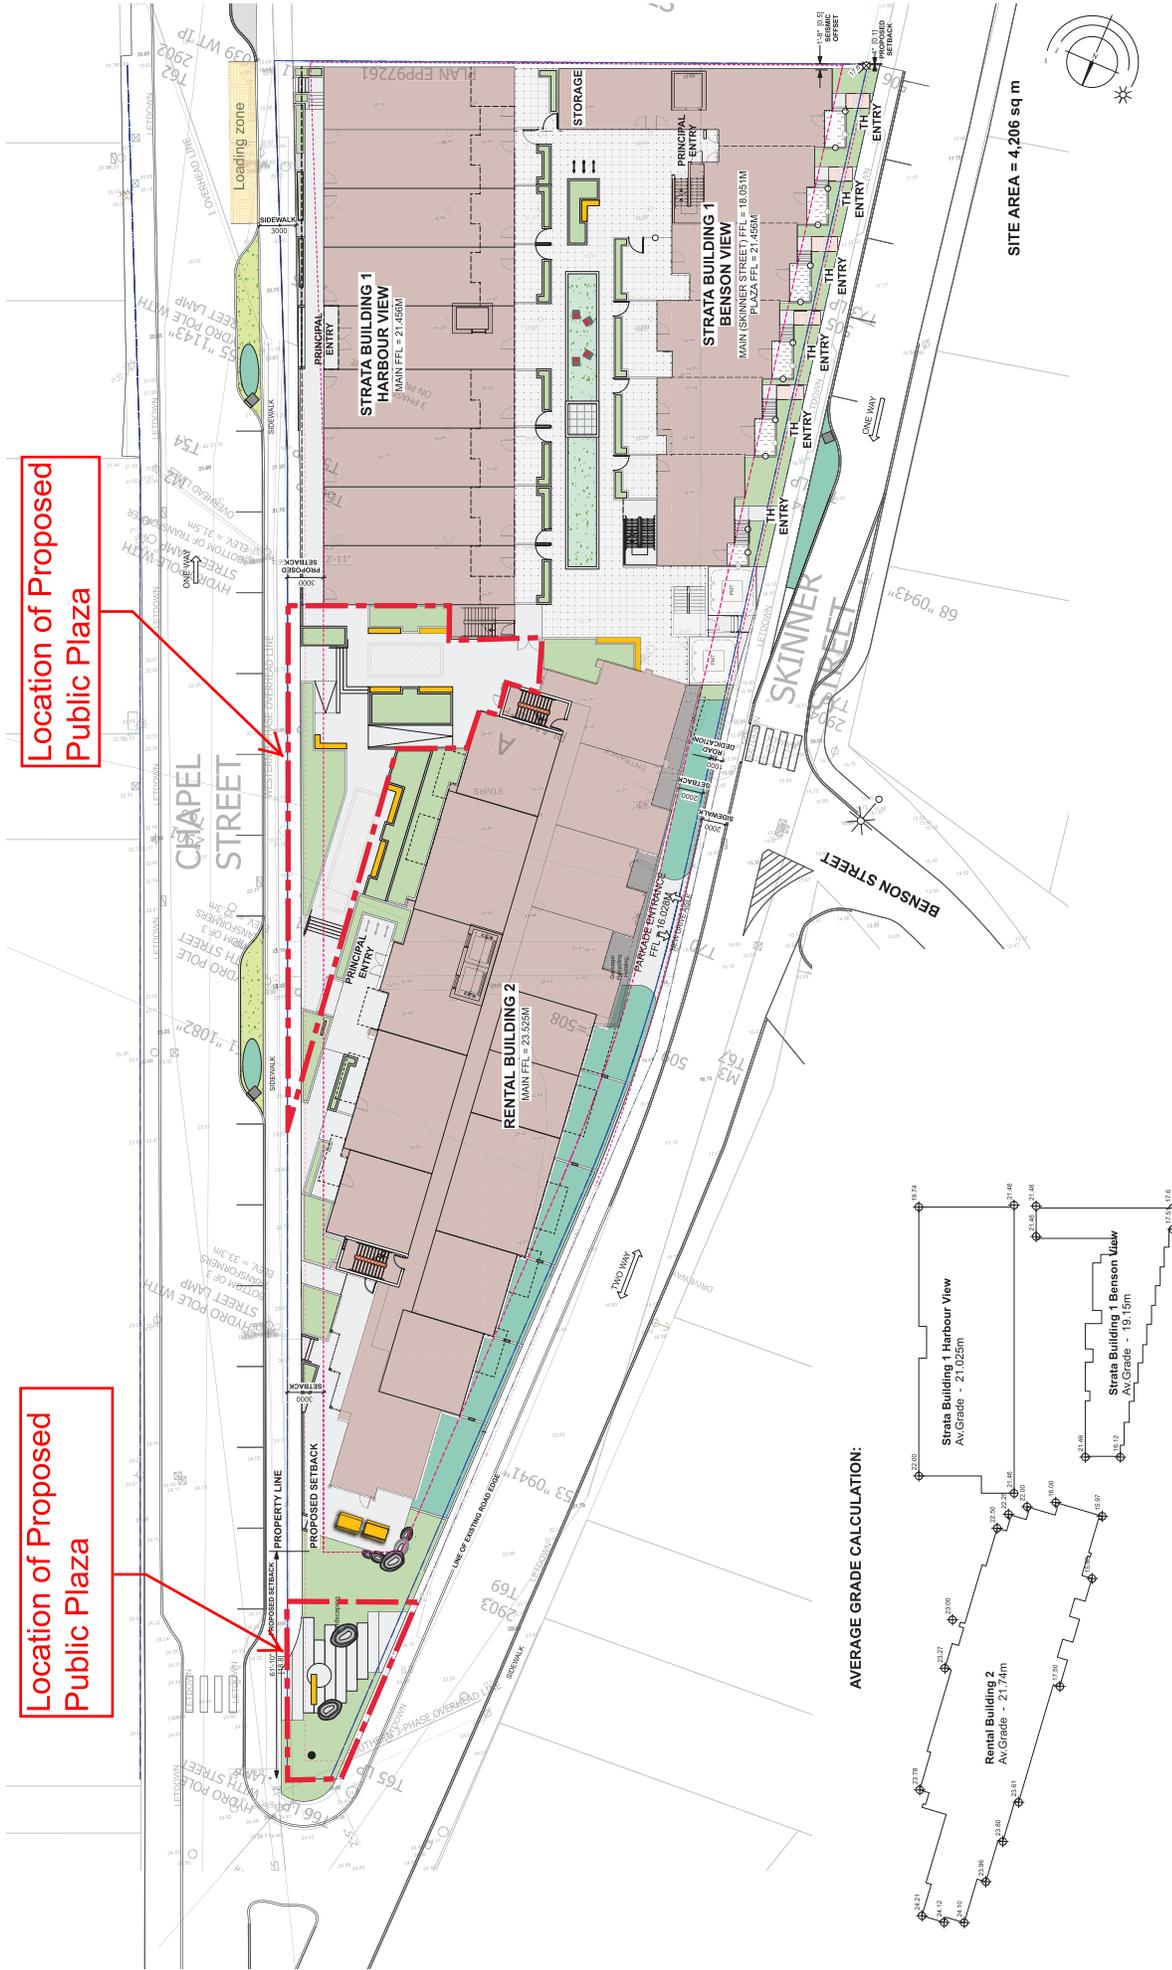

SITE AREA = 4,206 sq m



AVERAGE GRADE CALCULATION:

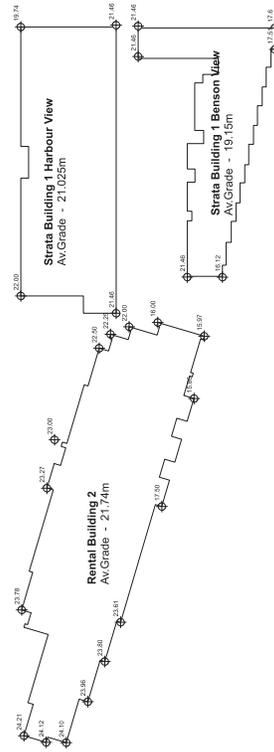

Location of Proposed Public Plaza

Location of Proposed Public Plaza

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DP1256
2022-MAR-16

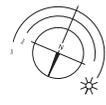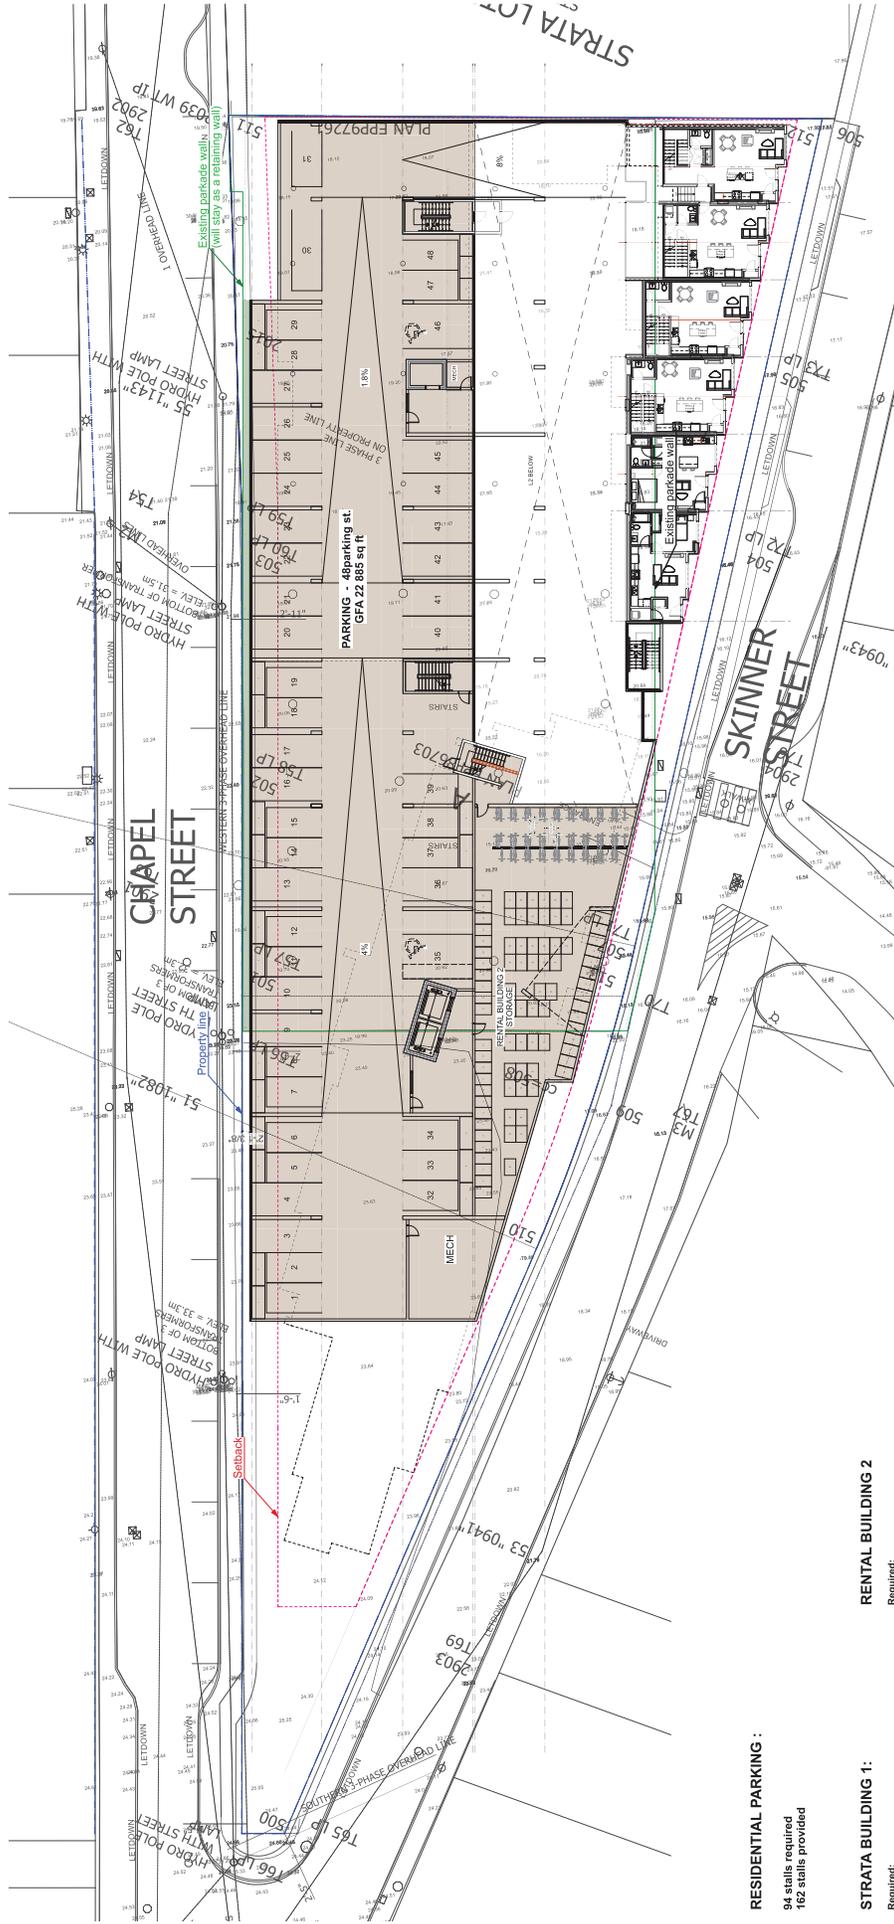


RESIDENTIAL PARKING :
94 stalls required
162 stalls provided

STRATA BUILDING 1:

Required:
Downtown Area 5: 265
R1M 210.0 = 43.0
2BDM 200.0 = 43.0
Studio 200.0 = 0.9
TOTAL (required) 44.4 STALLS
including:
Accessible parking - 3 stalls
Electric vehicles 25% - 11 stalls
Bicycle parking:
Electric vehicles units x 0.1 (space)
Long term - 36.5 (73units x 0.5space)

RENTAL BUILDING 2

Required:
Downtown Area 5: 265
R1M 210.0 = 43.9
2BDM 200.0 = 5.4
Studio 120.0 = 5.4
TOTAL (required) 50 STALLS
including:
Accessible parking - 3 stalls
Electric vehicles 25% - 13 stalls
Bicycle parking:
Electric vehicles units x 0.1 (space)
Long term - 42 (84units x 0.5space)

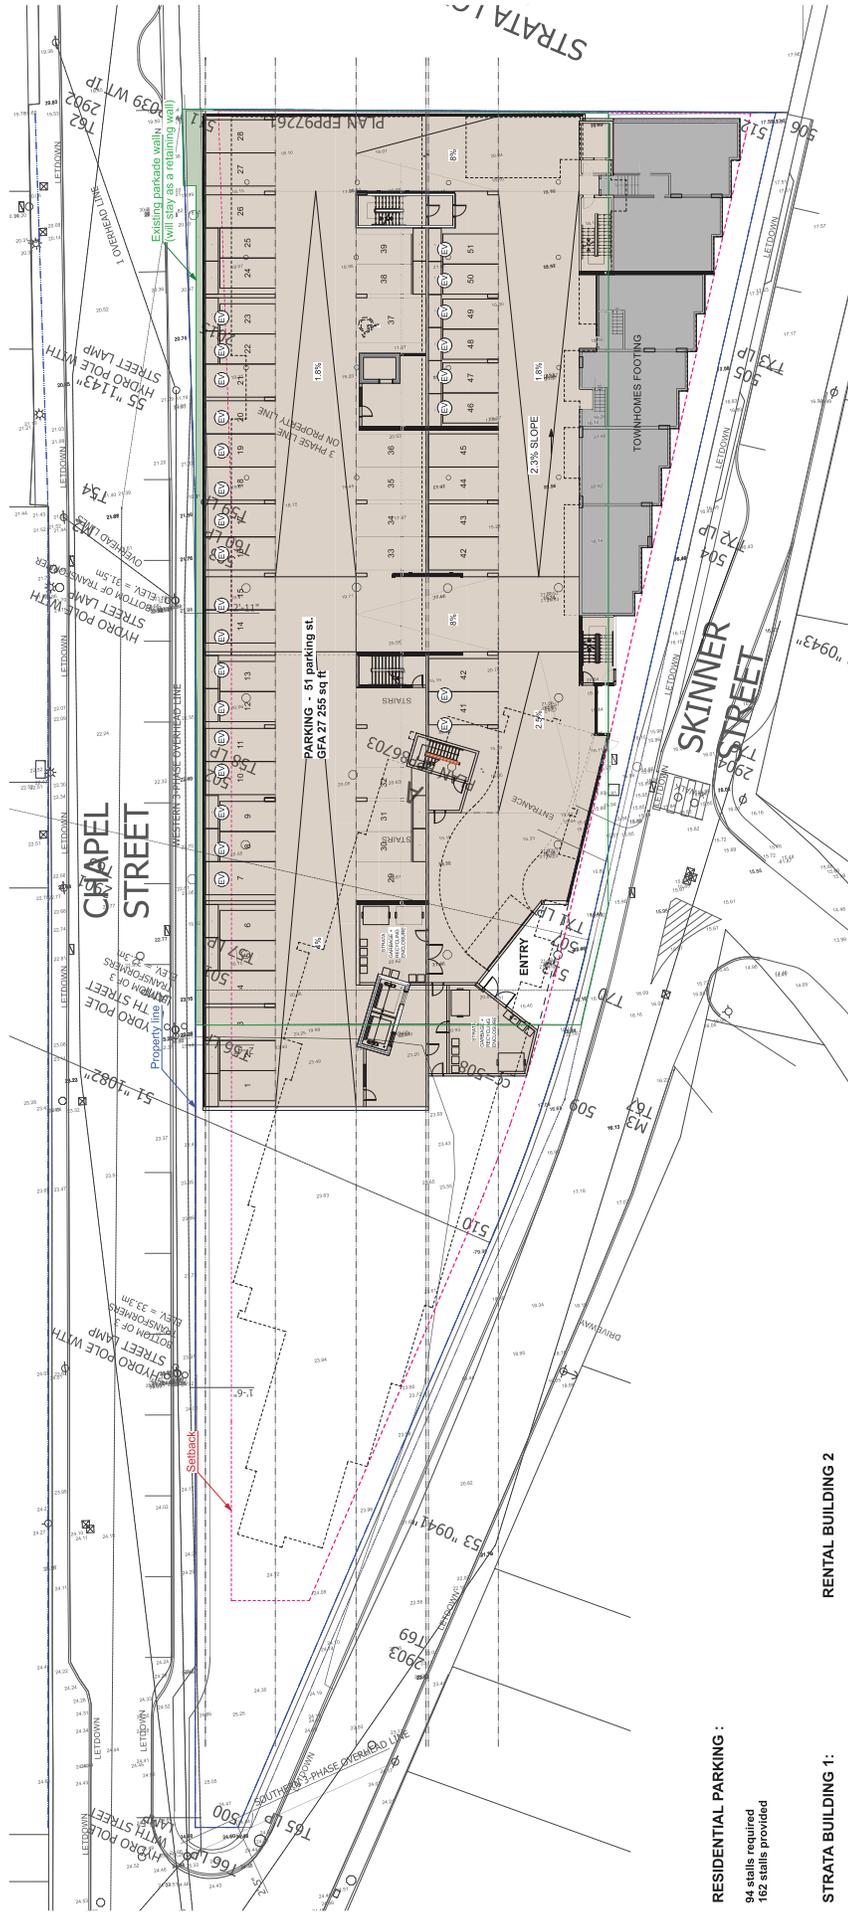

RESIDENTIAL PARKING :


94 stalls required
162 stalls provided

STRATA BUILDING 1:

Required:
Downtown Area 5: 265
ERF 1110.9 = 48.9
2BDM 2100.9 = 48.9
Studio 240.45 = 5.4
TOTAL (required) 44.4 STALLS
including:
Accessible parking - 3 stalls
Bicycle parking - 11 stalls
Electric vehicles 25% - 11 stalls
Bicycle parking:
36.5 (73units x 0.1space)
Long term - 36.5 (73units x 0.5space)

RENTAL BUILDING 2

Required:
Downtown Area 5: 265
ERF 1110.9 = 48.9
2BDM 2100.9 = 48.9
Studio 240.45 = 5.4
TOTAL (required) 50 STALLS
including:
Accessible parking - 3 stalls
Bicycle parking - 13 stalls
Electric vehicles 25% - 13 stalls
Bicycle parking:
42 (84units x 0.1space)
Long term - 42 (84units x 0.5space)

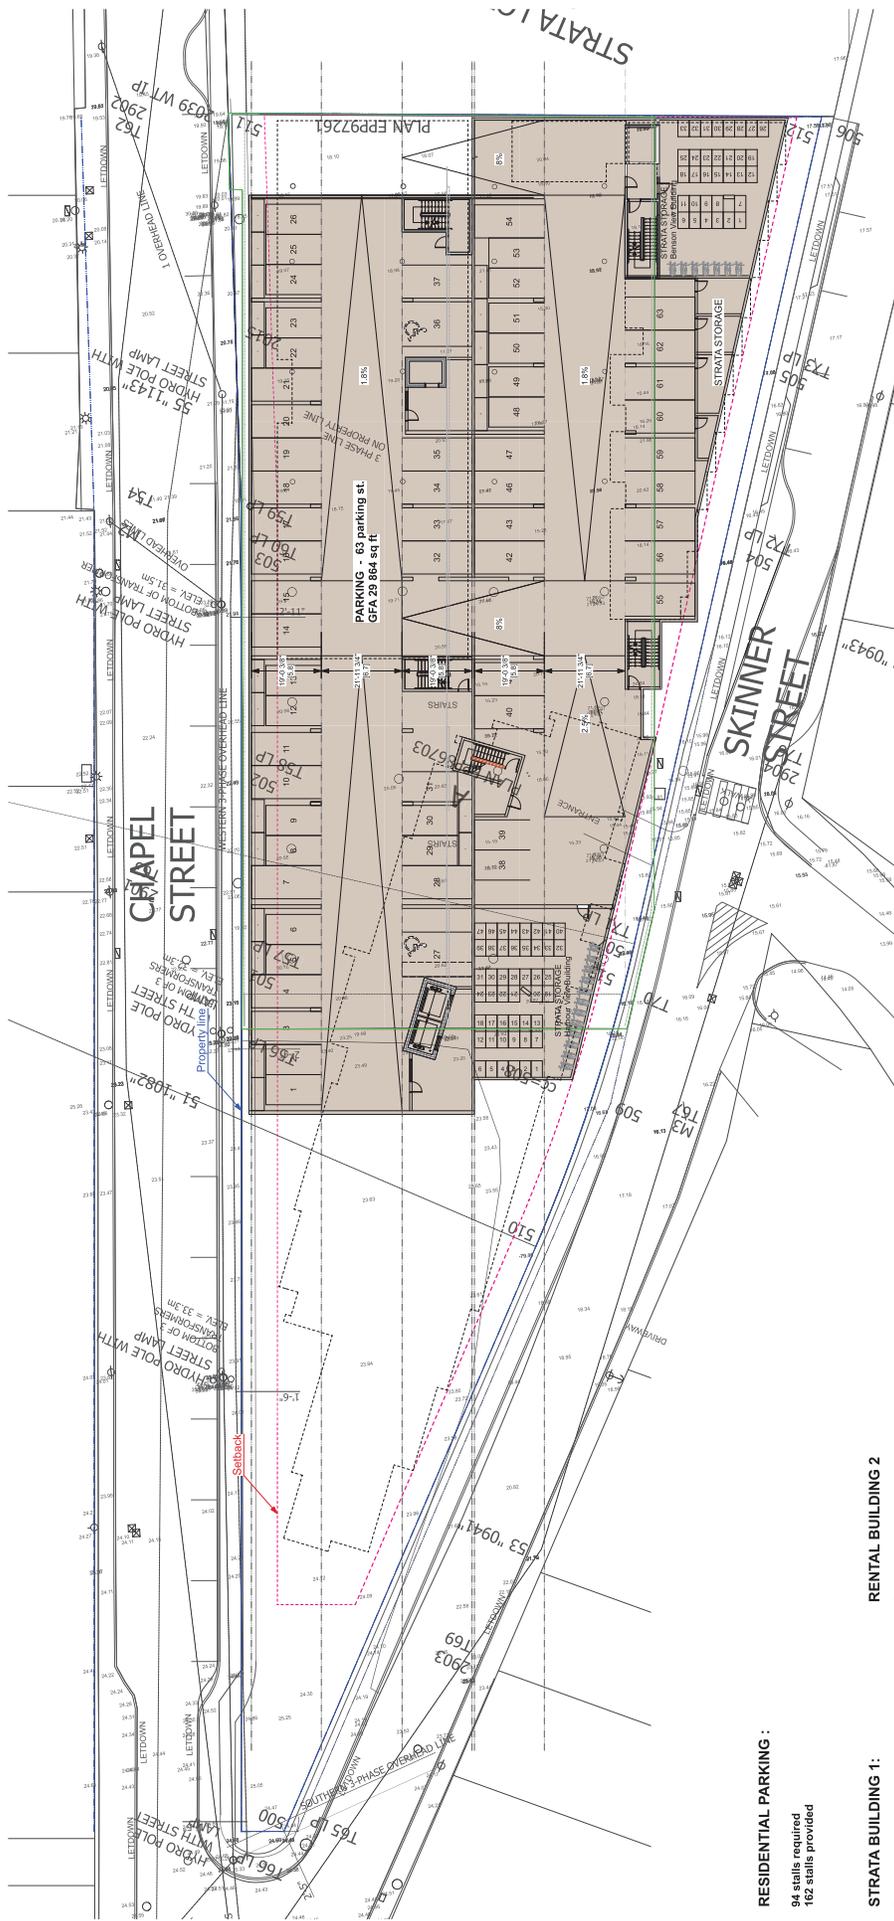

RESIDENTIAL PARKING :
 94 stalls required
 162 stalls provided

STRATA BUILDING 1:

Required:
 Downtown Area 5: 26.5
 1BDM 111.0 = 41.0
 2BDM 210.0 = 48.0
 Studio 240.45 = 0.9
TOTAL (required) 44.4 STALLS
 including:
 Accessible parking - 3 stalls
 Electric vehicles 25% - 11 stalls
Bicycle parking:
 10 units x 0.1 space)
 Long term - 36.5 (73units x 0.5space)

RENTAL BUILDING 2

Required:
 Downtown Area 5: 26.5
 1BDM 111.0 = 41.0
 2BDM 210.0 = 48.0
 Studio 240.45 = 0.9
TOTAL (required) 50 STALLS
 including:
 Accessible parking - 3 stalls
 Electric vehicles 25% - 13 stalls
Bicycle parking:
 10 units x 0.1 space)
 Long term - 42 (84units x 0.5space)

ATTACHMENT D BUILDING ELEVATIONS AND DETAILS

1 of 7



91 CHAPEL STREET

MAIN ENTRY
STRATA BUILDING
HARBOUR VIEW

CHAPEL STREET

RENTAL BUILDING

MAIN ENTRY

1 Chapel Street - Streetscape East Elevation
A300 / Scale: 1/16" = 1'-0"



RENTAL BUILDING

PARKADE ENTRY

SKINNER STREET

STRATA BUILDING
BENSEN VIEW

91 CHAPEL STREET

2 Skinner Street - Streetscape West Elevation
A300 / Scale: 1/16" = 1'-0"

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77 Chapel Street / DP Revision

Nanaimo, BC
1080823

Strata Building Harbour View - Chapel Street Elevation 1/8" = 1'-0"

dhk architects


dhka

- GENERAL NOTES**
1. ALL WORK TO CONFORM TO THE BCBC 2018 BUILDING CODE
 2. ALL EXISTING AND NEW MATERIALS ARE QUOTED AND SHOWN IN METERS.
 3. CONTRACTOR TO VERIFY ALL DIMENSIONS AND CONFIRM SAME ON SITE.
 4. PROVIDE GUARDRAILS AT RETAINING WALLS OVER 2' IN HEIGHT.
 5. SUBMITTED THROUGH AN AT THREE SIGN PERMIT APPLICATION.

1 Strata Building - Harbour View - East Elevation (Facing Chapel St)
A301 Scale: 1/8" = 1'-0"

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0 2'-0" 10'-0" 20'-0"
1" = 10'-0"

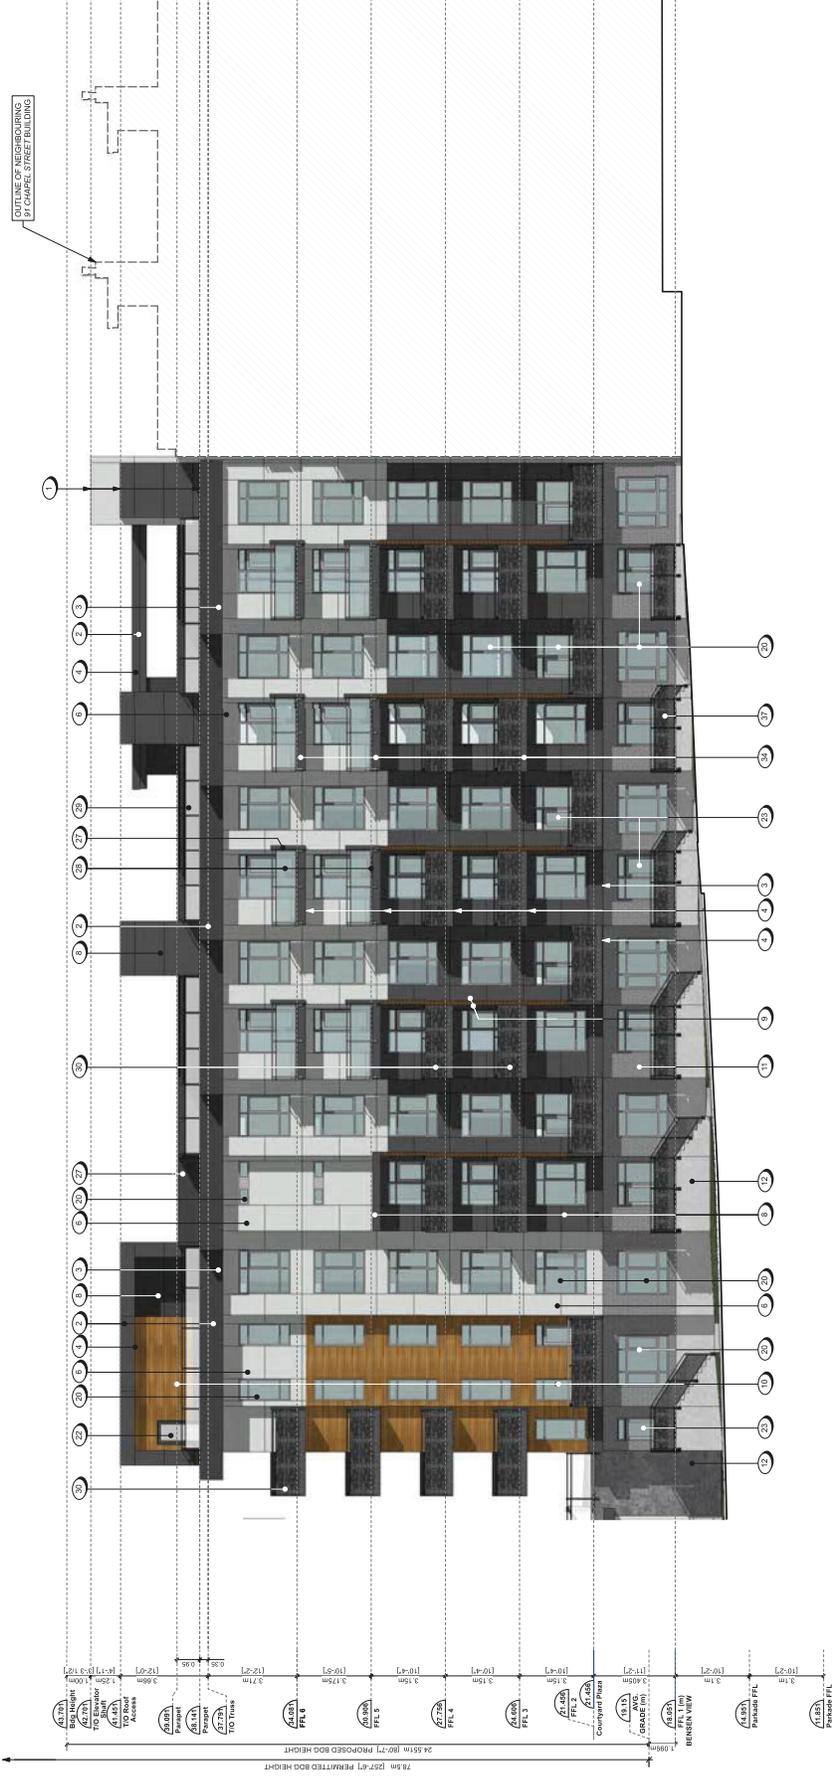

Strata Building - Benson View - West Elevation (Facing Skinner St)
Scale: 1/8" = 1'-0"

GENERAL NOTES

1. ALL WORK TO CONFORM TO THE BCBC 2018 BUILDING CODE
2. ALL EXISTING AND NEW DIMENSIONS ARE GEOMETRIC AND SHOWN IN METERS
3. CONTRACTOR TO VERIFY ALL DIMENSIONS AND CONFIRM SAME ON SITE.
4. PROVIDE GUARDRAILS AT RETAINING WALLS OVER 2' IN HEIGHT
5. SUBMITTED THROUGH A FUTURE SIGN PERMIT APPLICATION.

- MATERIAL PALETTE**
- 01 LOW SLOPE MEMBRANE ROOF, DARK GREY TONES
 - 02 FIBRE CEMENT PANEL, FACIA, SMOOTH TEXTURE, IN TROSY GREY, WITH ALUMINIUM CAP FLASHING, IN CHARCOAL GREY
 - 03 WOODS LOOK METAL, SMOOTH+V-GROOVE, VENTED RAFFTS, WOOD GRAIN FINISH, IN SPR
 - 04 SMOOTH+V-GROOVE, VENTED RAFFTS, WOOD GRAIN FINISH, IN SPR
 - 05 SMOOTH+V-GROOVE, VENTED RAFFTS, SMOOTH TEXTURE, IN PEAKAL GREY
 - 06 FIBRE CEMENT PANEL, SMOOTH TEXTURE, IN PEAKAL GREY
 - 07 FIBRE CEMENT PANEL, SMOOTH TEXTURE, IN TROSY GREY
 - 08 WOODS LOOK METAL, SMOOTH+V-GROOVE, PANEL SING, WOOD GRAIN FINISH, IN DARK CHERRY
 - 09 WOODS LOOK METAL, SMOOTH+V-GROOVE, PANEL SING, WOOD GRAIN FINISH, IN SPR
 - 10 WOODS LOOK METAL, SMOOTH+V-GROOVE, PANEL SING, WOOD GRAIN FINISH, IN TROSY GREY
 - 11 CAST-IN-PLACE CONCRETE WALL AND COLUMNS, SMOOTH FINISH, PAINT SEALED IN LIGHT GREY TONES
 - 12 INSULATED CONCRETE WALL, SMOOTH FINISH, PAINT SEALED IN CHARCOAL GREY
 - 13 INSULATED CONCRETE PANEL, DARK GREY TONES
 - 14 ALUMINIUM CURTAIN WALL GLAZING, IN REGENT GREY
 - 15 ALUMINIUM CURTAIN WALL GLAZING, IN TROSY GREY
 - 16 SPANDREL PANEL
 - 17 FIBRE CEMENT PANEL, SMOOTH TEXTURE, IN REGENT GREY, WITH CLEAR TEMPERED GLASS INFILL PANELS
 - 18 ALUMINIUM STORE FRONT DOORS, IN CHARCOAL GREY, WITH CLEAR TEMPERED GLASS INFILL PANELS
 - 19 VINYL WINDOWS, IN REGENT GREY
 - 20 VINYL SLIDING GLASS DOORS, IN REGENT GREY
 - 21 VINYL SLIDING GLASS DOORS, IN TROSY GREY
 - 22 VINYL SLIDING GLASS DOORS, IN CHARCOAL GREY
 - 23 VINYL SLIDING GLASS DOORS, IN REGENT GREY
 - 24 VINYL SLIDING GLASS DOORS, IN TROSY GREY
 - 25 VINYL SLIDING GLASS DOORS, IN CHARCOAL GREY
 - 26 VINYL SLIDING GLASS DOORS, IN REGENT GREY
 - 27 VINYL SLIDING GLASS DOORS, IN TROSY GREY
 - 28 VINYL SLIDING GLASS DOORS, IN CHARCOAL GREY
 - 29 VINYL SLIDING GLASS DOORS, IN REGENT GREY
 - 30 VINYL SLIDING GLASS DOORS, IN TROSY GREY

- 31 ALUMINIUM, HEAVY DUTY, ANTI-SCUFF PANELS, WITH V-GROOVE, FIBRE CEMENT PANEL SING, IN TROSY GREY
- 32 ALUMINIUM RAILING AND GUARDRAILS, IN TROSY GREY FINISH, WITH CLEAR TEMPERED GLASS PANELS
- 33 ALUMINIUM RAILING AND GUARDRAILS, IN CHARCOAL GREY FINISH, WITH CLEAR TEMPERED GLASS PANELS
- 34 ALUMINIUM RAILING AND GUARDRAILS, IN CHARCOAL GREY FINISH, WITH DECORATIVE PERFORATED METAL INFILL PANELS
- 35 PRIVACY SCREEN, ALUMINIUM FRAME WITH Frosted TEMPERED GLASS PANELS
- 36 ALUMINIUM RAILING AND GUARDRAILS WITH PICKETS, IN CHARCOAL GREY
- 37 ALUMINIUM RAILING AND GUARDRAILS WITH PICKETS, IN TROSY GREY
- 38 CONCRETE ELEVATED WALKWAYS WITH PAVER WALKING SURFACE, IN LIGHT GREY
- 39 EXTERIOR METAL STAIRS, IN REGENT GREY FINISH, WITH CLEAR TEMPERED GLASS INFILL PANELS
- 40 CONCRETE FLOOR AND STAIRS, WITH ALUMINIUM RAILING AND GUARDRAILS, IN CHARCOAL GREY FINISH
- 41 PRIVACY SCREEN, ALUMINIUM FRAME WITH DECORATIVE PERFORATED METAL INFILL PANELS, IN CHARCOAL GREY TONES
- 42 PRIVACY SCREEN, ALUMINIUM FRAME WITH DECORATIVE PERFORATED METAL INFILL PANELS, IN TROSY GREY TONES
- 43 RECOMMEND SCREEN DOORS, METAL FRAME, IN TROSY GREY FINISH, PAINT SEALED IN CHARCOAL GREY
- 44 ALUMINIUM WINDOW OPENING PICKETS, IN BLACK
- 45 METAL PANEL SING, IN SLATE GREY
- 46 FIBRE FINISHED METAL FLASHING TO COLOUR MATCH MATERIALS
- 47 ALUMINIUM FLASHING, IN SLATE GREY, WEATHERFORM METALS
- 48 ALUMINIUM FLASHING, IN SLATE GREY, WEATHERFORM METALS
- 49 ALUMINIUM FLASHING, IN CHARCOAL GREY, WEATHERFORM METALS

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1 Rental Building - East Elevation (Facing Chapel St)
 A304
 Scale: 1/8" = 1'-0"

- MATERIAL PALETTE**
- 1 ALUMINUM CLAD ROOF PANELS WITH CHARCOAL GREY FINISH
 - 2 WOOD-LOOK METAL SPURTS WITH ALUMINUM CAP FLASHINGS IN CHARCOAL GREY
 - 3 WOOD-LOOK METAL SPURTS WITH ALUMINUM CAP FLASHINGS IN CHARCOAL GREY
 - 4 WOOD-LOOK METAL SPURTS WITH ALUMINUM CAP FLASHINGS IN CHARCOAL GREY
 - 5 WOOD-LOOK METAL SPURTS WITH ALUMINUM CAP FLASHINGS IN CHARCOAL GREY
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 - 8 WOOD-LOOK METAL SPURTS WITH ALUMINUM CAP FLASHINGS IN CHARCOAL GREY
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 - 35 WOOD-LOOK METAL SPURTS WITH ALUMINUM CAP FLASHINGS IN CHARCOAL GREY
 - 36 WOOD-LOOK METAL SPURTS WITH ALUMINUM CAP FLASHINGS IN CHARCOAL GREY

- 1 ALUMINUM CLAD ROOF PANELS WITH CHARCOAL GREY FINISH
- 2 WOOD-LOOK METAL SPURTS WITH ALUMINUM CAP FLASHINGS IN CHARCOAL GREY
- 3 WOOD-LOOK METAL SPURTS WITH ALUMINUM CAP FLASHINGS IN CHARCOAL GREY
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- 5 WOOD-LOOK METAL SPURTS WITH ALUMINUM CAP FLASHINGS IN CHARCOAL GREY
- 6 WOOD-LOOK METAL SPURTS WITH ALUMINUM CAP FLASHINGS IN CHARCOAL GREY
- 7 WOOD-LOOK METAL SPURTS WITH ALUMINUM CAP FLASHINGS IN CHARCOAL GREY
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- 33 WOOD-LOOK METAL SPURTS WITH ALUMINUM CAP FLASHINGS IN CHARCOAL GREY
- 34 WOOD-LOOK METAL SPURTS WITH ALUMINUM CAP FLASHINGS IN CHARCOAL GREY
- 35 WOOD-LOOK METAL SPURTS WITH ALUMINUM CAP FLASHINGS IN CHARCOAL GREY
- 36 WOOD-LOOK METAL SPURTS WITH ALUMINUM CAP FLASHINGS IN CHARCOAL GREY

GENERAL NOTES

1. ALL WORK TO CONFORM TO THE BCBC 2018 BUILDING CODE.
2. ALL EXISTING AND NEW DIMENSIONS ARE GEOMETRIC AND SHOWN IN METERS.
3. CONTRACTOR TO VERIFY ALL DIMENSIONS AND CONFORM SAME ON SITE.
4. PROVIDE GUARDRAILS AT RETAINING WALLS OVER 2' IN HEIGHT.
5. SUBMITTED THROUGH A CIVIL ENGINEER PERMIT APPLICATION.

RECEIVED
 DP 11
 2023-MAR-16
 0 2'-0" 10'-0" 20'-0"
 1/8" = 1'-0"




1 Rental Building - West Elevation (Facing Skinner St)
 A3057 Scale: 1/8" = 1'-0"

- MATERIAL PALETTE**
- 1 FIBRE CEMENT PANEL, FACIA, SMOOTH TEXTURE, IN TROUS GREY, WITH ALUMINIUM GAP FLASHINGS, IN CHARCOAL GREY
 - 2 WOOD-LOOK METAL SHIPFIT SMOOTH+V-GROOVE VENTED SHIPFIT WOOD GRAIN FINISH, IN FPK
 - 3 SHIPFIT VENTED FIBRE CEMENT PANEL, SHIPFIT, SMOOTH TEXTURE, IN PEAKAL GREY
 - 4 FIBRE CEMENT PANEL, SMOOTH TEXTURE, IN PEAKAL GREY
 - 5 WOOD-LOOK METAL SHIPFIT SMOOTH+V-GROOVE PANEL, SMOOTH WOOD GRAIN FINISH, IN DARK CHERRY
 - 6 WOOD-LOOK METAL SHIPFIT SMOOTH+V-GROOVE PANEL, SMOOTH WOOD GRAIN FINISH, IN FPK
 - 7 CAST-IN-PLACE CONCRETE WALL AND COLUMN, SMOOTH FINISH, PAINT SEALED IN LIGHT GREY TONES
 - 8 INSULATED CONCRETE PANEL, SMOOTH FINISH, PAINT SEALED IN CHARCOAL GREY
 - 9 ALUMINIUM CURTAIN WALL GLAZING, IN REGENT GREY
 - 10 SPANDREL PANEL
 - 11 ALUMINIUM CURTAIN WALL GLAZING, IN REGENT GREY
 - 12 ALUMINIUM STORE FRONT DOOR, IN CHARCOAL GREY, WITH CLEAR TEMPERED GLASS INELL PANELS
 - 13 VINYL WINDOWS, IN REGENT GREY
 - 14 VINYL SLIDING GLASS DOOR, IN REGENT GREY
 - 15 VINYL SLIDING GLASS DOOR, IN REGENT GREY
 - 16 VINYL SLIDING GLASS DOOR, IN REGENT GREY
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 - 26 VINYL SLIDING GLASS DOOR, IN REGENT GREY
 - 27 VINYL SLIDING GLASS DOOR, IN REGENT GREY
 - 28 VINYL SLIDING GLASS DOOR, IN REGENT GREY
 - 29 ALUMINIUM RAILING AND GUARDRAIL, IN CHARCOAL GREY, WITH CLEAR TEMPERED GLASS PANELS
 - 30 ALUMINIUM RAILING AND GUARDRAIL, IN CHARCOAL GREY, WITH CLEAR TEMPERED GLASS PANELS
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 5. SUBMITTED THROUGH A FUTURE SIGN PERMIT APPLICATION

RECEIVED
 DP1256
 2023-MAR-10
 10:00
 0.2" = 1'-0"
 10' 0" = 1'-0"

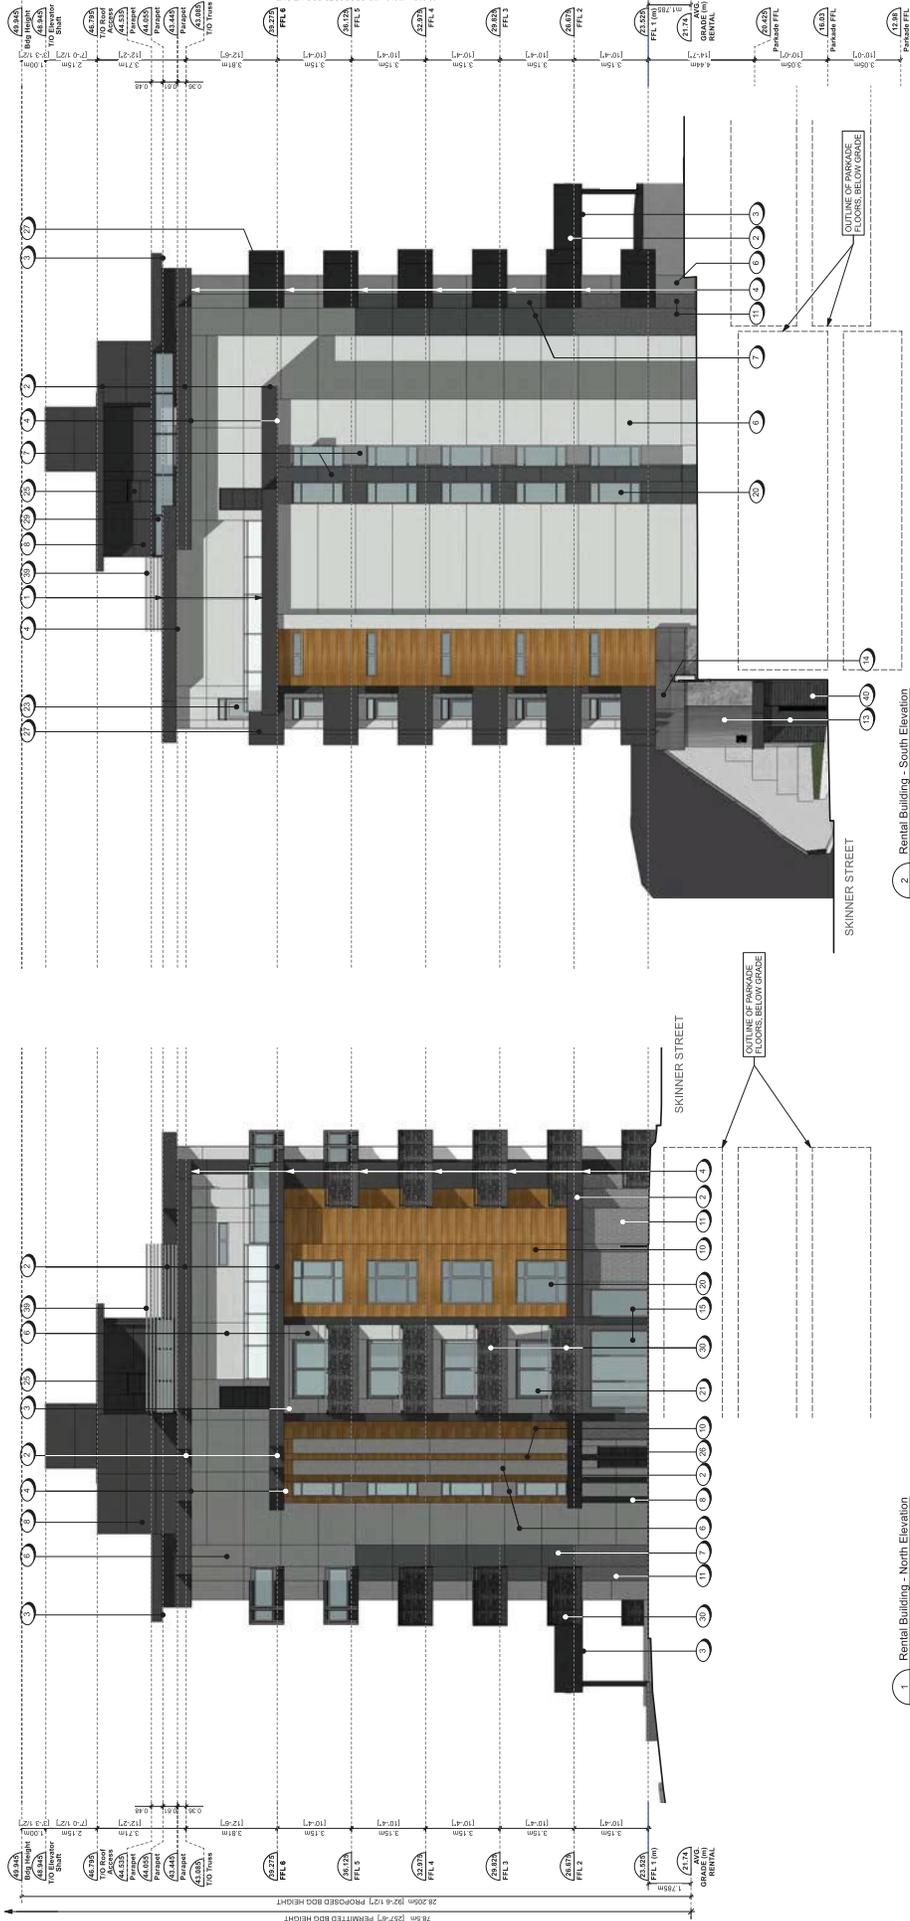

1 Rental Building - North Elevation
A306 Scale: 1/8" = 1'-0"

2 Rental Building - South Elevation
A306 Scale: 1/8" = 1'-0"

MATERIAL PALETTE

- 1 LOW SLOPE MEMBRANE ROOF, IN DARK GREY TONES
- 2 FIBRE CEMENT PANEL, FACIA, SMOOTH TEXTURE, IN TROKY GREY, WITH ALUMINUM GAP FLASHING, IN CHARCOAL GREY
- 3 WOOD-LOOK METAL SHEET, SMOOTH+V-GROOVE VENTED SHOFFS, WOOD GRAIN FINISH, IN FIR
- 4 VENTED FIBRE CEMENT PANEL, DOTTED, SMOOTH TEXTURE, IN PEARL GREY
- 5 FIBRE CEMENT PANEL, SMOOTH TEXTURE, IN PEARL GREY
- 6 FIBRE CEMENT PANEL, SMOOTH TEXTURE, IN SLATE GREY
- 7 WOOD-LOOK METAL SHEET, SMOOTH+V-GROOVE PANEL, SMOOTH, WOOD GRAIN FINISH, IN DARK CHERRY
- 8 WOOD-LOOK METAL SHEET, SMOOTH+V-GROOVE PANEL, SMOOTH, WOOD GRAIN FINISH, IN FIR
- 9 STAINLESS STEEL, SMOOTH, IN TROKY GREY
- 10 CAST-IN-PLACE CONCRETE, WALL AND COLUMNS, SMOOTH FINISH, PAINT SEALED IN LIGHT GREY TONES
- 11 INDICATED CONCRETE PANEL, SMOOTH FINISH, PAINT SEALED IN CHARCOAL GREY
- 12 INDICATED CONCRETE PANEL, SMOOTH FINISH, PAINT SEALED IN CHARCOAL GREY
- 13 ALUMINUM CURTAIN WALL GLAZING, IN TROKY GREY
- 14 SPANDREL PANEL
- 15 ALUMINUM CURTAIN WALL GLAZING, IN TROKY GREY
- 16 ALUMINUM STORE FRONT DOOR, IN CHARCOAL GREY, WITH CLEAR TEMPERED GLASS INFILL PANELS
- 17 VINYL WINDOWS, IN TROKY GREY
- 18 VINYL SLIDING GLASS DOOR, IN TROKY GREY
- 19 VINYL SLIDING GLASS DOOR, IN TROKY GREY
- 20 VINYL SLIDING GLASS DOOR, IN TROKY GREY
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- 27 VINYL SLIDING GLASS DOOR, IN TROKY GREY


- 28 ALUMINUM, VERTICAL FINISH, WITH FIBRE CEMENT PANEL, SMOOTH TEXTURE, IN TROKY GREY
- 29 ALUMINUM, HORIZONTAL AND QUADRABLE, IN TROKY GREY FINISH, WITH CLEAR TEMPERED GLASS PANELS
- 30 ALUMINUM, HORIZONTAL AND QUADRABLE, IN CHARCOAL GREY FINISH, WITH CLEAR TEMPERED GLASS PANELS
- 31 ALUMINUM, HORIZONTAL AND QUADRABLE, IN CHARCOAL GREY FINISH, WITH DECORATIVE PERFORATED METAL INFILL PANELS
- 32 PRIVACY SCREEN, ALUMINUM FRAME WITH FROSTED TEMPERED GLASS PANELS
- 33 ALUMINUM, HORIZONTAL AND QUADRABLE, WITH FROSTED TEMPERED GLASS PANELS
- 34 ALUMINUM, HORIZONTAL AND QUADRABLE, WITH FROSTED TEMPERED GLASS PANELS
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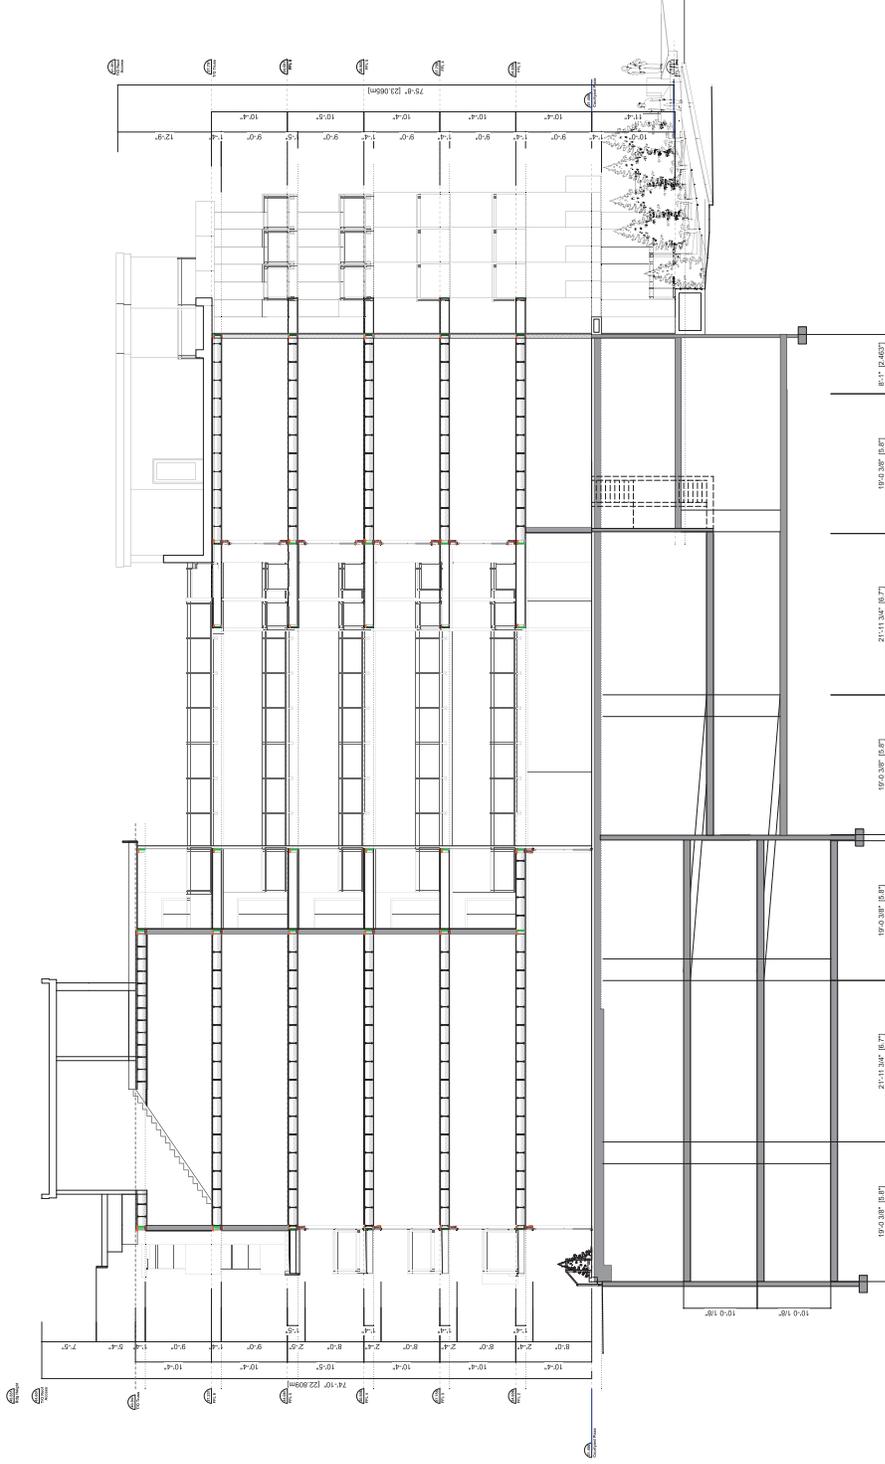
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4. PROVIDE GUARDRAILS AT RETAINING WALLS OVER 2' IN HEIGHT.
5. SUBMITTED THROUGH A VULNERABILITY PERMIT APPLICATION.




ATTACHMENT E BUILDING SECTIONS



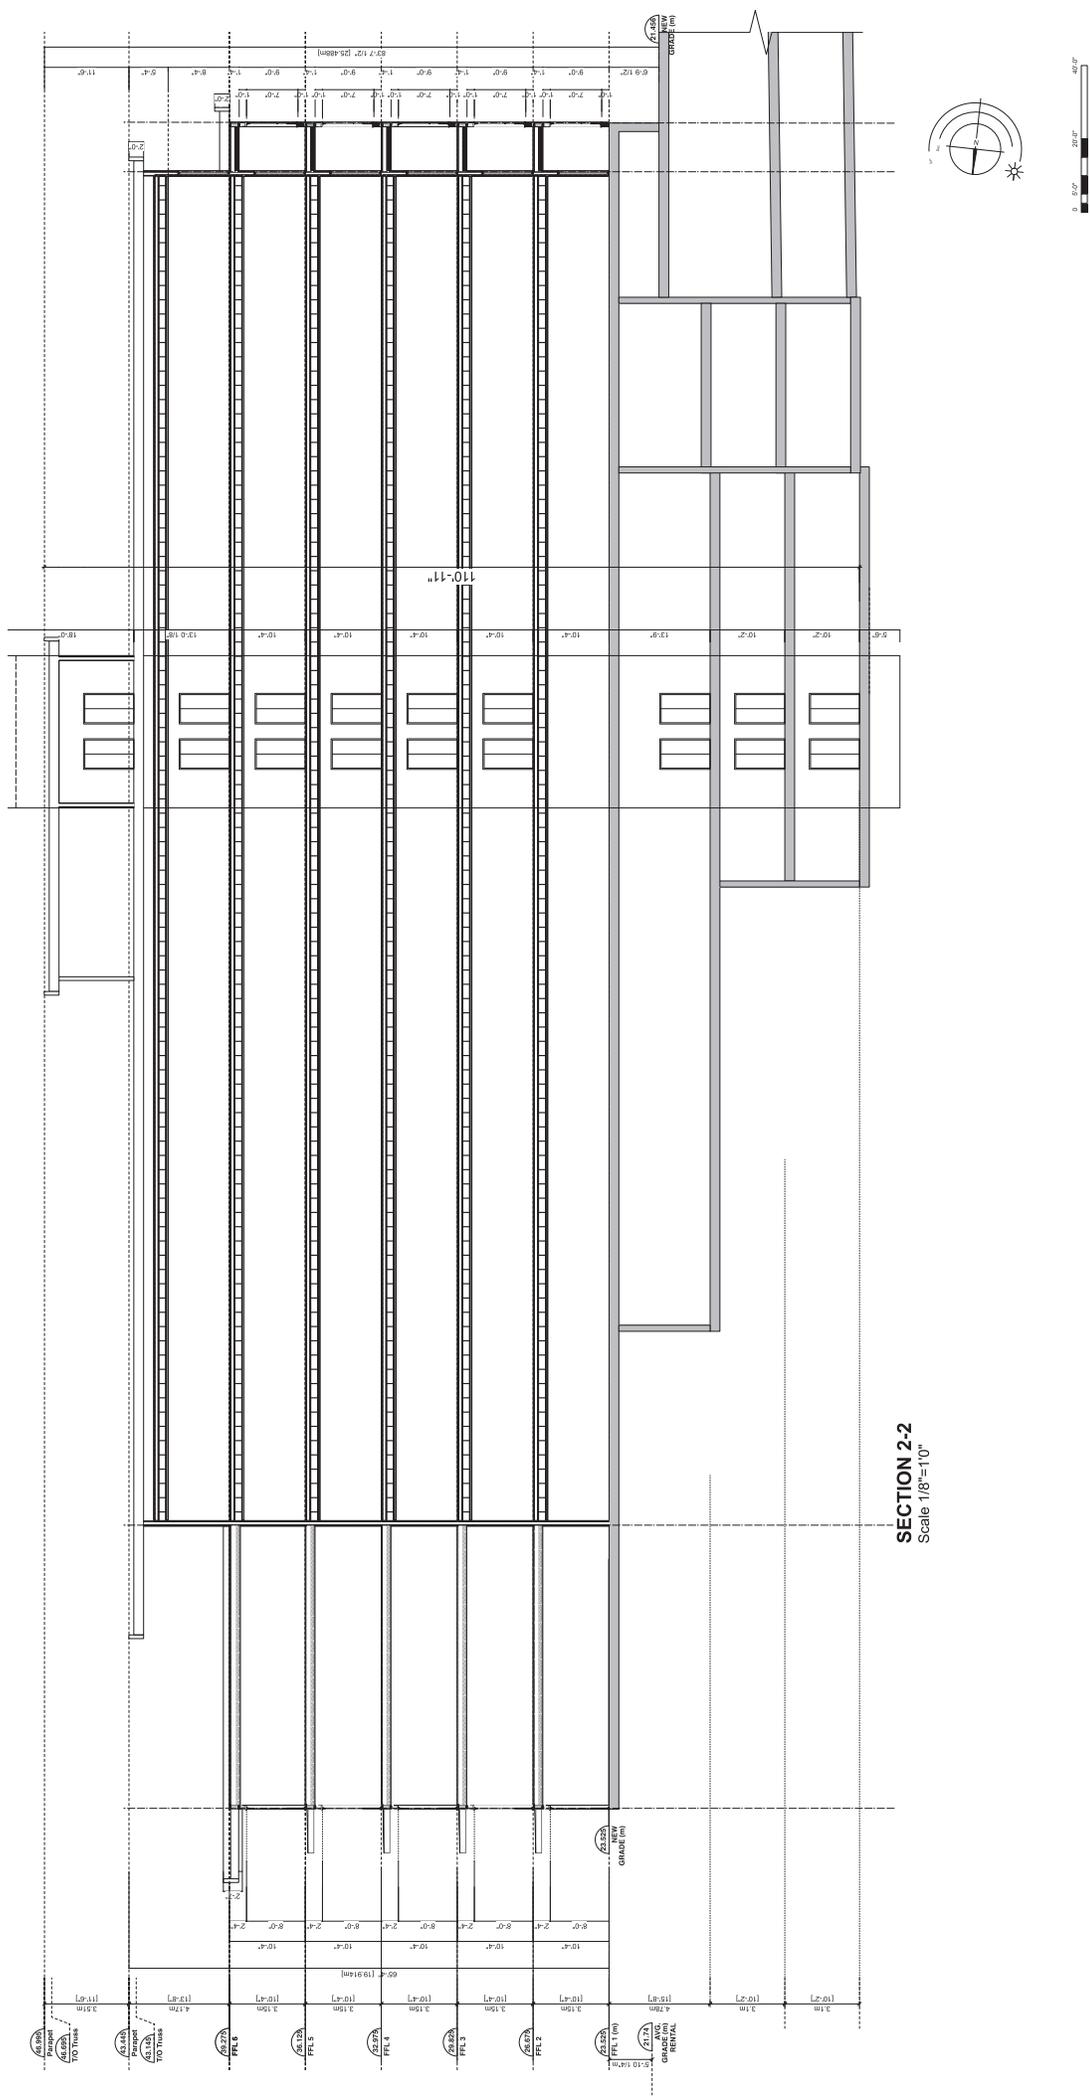

SECTION 3-3
Scale 1/8"=1'-0"

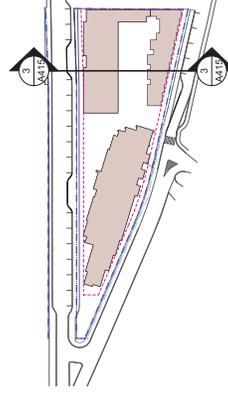

ATTACHMENT F BUILDING RENDERINGS

1 of 3



RECEIVED
DP 1256
2022-DEC-02
City of Nanaimo

Nanaimo, BC
08 NOV 22

77 Chapel Street

View 1. Looking South along Chapel Street

dHKarchitects



RECEIVED
DP1256
2022-DEC-02
CARRUTHERS PLANNING

77 Chapel Street

Nanaimo, BC
08 NOV 22

View 2. Looking South at Plaza from Chapel Street

dHKarchitects



RECEIVED
DP1256
2022-DEC-02

77 Chapel Street

Nanaimo, BC
08 NOV 22

View 8. Looking South along Skinner Street

dHKarchitects

ATTACHMENT G LANDSCAPE PLANS AND DETAILS

Westmark Construction Ltd
77 Chapel
 Nanaimo, British Columbia

Landscape Sheets	
Sheet No.	Sheet Title
L0.00	Cover
L0.01	General Information
L0.02	Stormwater Management
L1.01	Landscape Overview
L1.02	Site Plan
L1.03	Landscape Materials - Roof
L2.01	Landscape Grading & Drainage
L2.02	Landscape Grading & Drainage
L2.03	Landscape Elevations
L3.01	Planting Plan
L3.02	Planting Plan



rev no	description	date
4	DP Re-submission	2023-02-23
3	DP Re-submission	2023-01-26
2	DP Re-submission	2022-11-08
1	DP	11/19/2021

Murdoch de Greeff
 LANDSCAPE ARCHITECTS & PLANNERS
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 Tel: 604.273.4444 Fax: 604.273.4445
 www.murdochdegreff.com

Scott Murdoch
 341
 2177 AUSTIN ST.
 NANAIMO, BC V9S 2G5

client: **Westmark Construction Ltd.**
 77-2635 West Cough Road
 Nanaimo, BC

project: **77 Chapel**
 77 Chapel
 Nanaimo, BC

sheet no: **Cover**

project no:	121.34
scale:	1:200 @ 24"x36"
drawn by:	MDI
checked by:	SM
revision:	Sheet no.
L0.00	

4	DP Re-submission	2023-02-23
3	DP Re-submission	2023-01-26
2	DP Re-submission	2022-11-08
1	DP	11/19/2021
rev no	description	date

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Scott Murdoch
Professional Engineer
No. 341
2023-02-23

client
Westmark Construction Ltd.
#1-2635, 160 Coughlin Road
Nanaimo, BC

Project
77 Chapel
77 Chapel
Nanaimo, BC

Project no. 121.34

Scale 1:200 @ 21" x 36"


Drawn by MDI

Checked by SM

Revised no. _____

Sheet no. **L0.02**

Stormwater Management

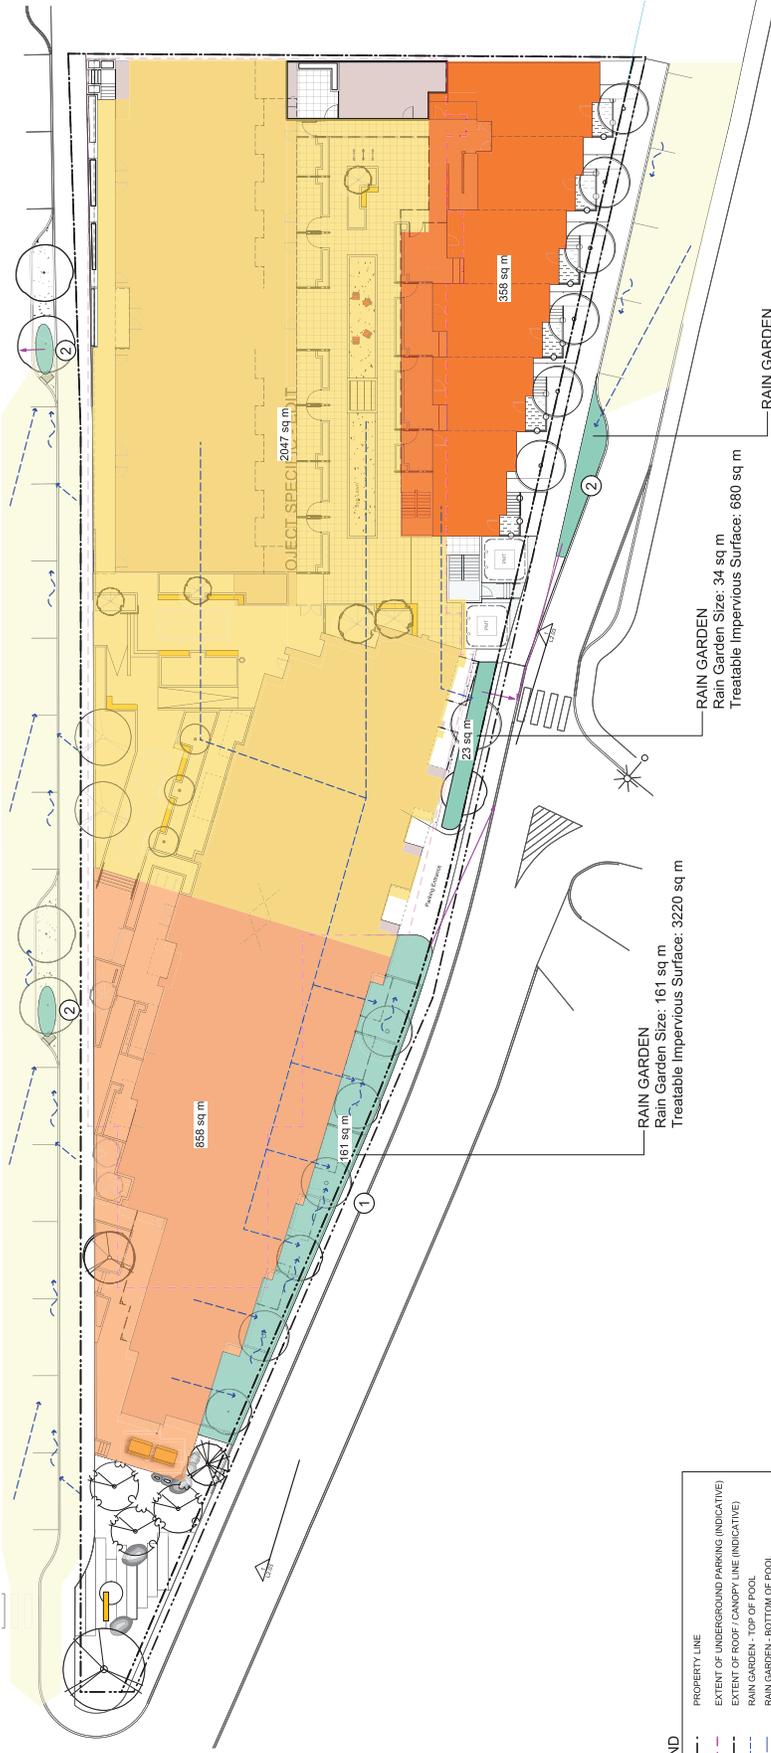

RAIN GARDEN
Rain Garden Size: 21 sq m
Treatable Impervious Surface: 420 sq m

RAIN GARDEN
Rain Garden Size: 34 sq m
Treatable Impervious Surface: 680 sq m


RAIN GARDEN
Rain Garden Size: 161 sq m
Treatable Impervious Surface: 3220 sq m



2. Street surface runoff collection into rain garden.



1. Terraced rain gardens along building.

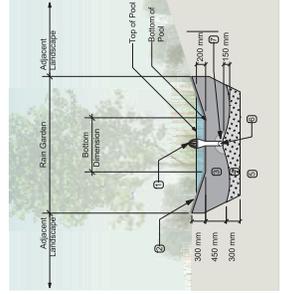

- RAIN GARDEN MATERIALS**
1. Overflow drain, 200 mm rounded grate + adipose
 2. 200 mm rounded grate
 3. Bio-retention growing medium, 450 mm depth
 4. Sand-filled substrate, 300 mm depth
 5. 100 mm diameter (min) perforated pipe
 6. 100 mm diameter (min) perforated pipe
 7. 25 mm diameter drain rock, 100 mm depth

1 Typical Rain Garden
Scale: 1:50

LEGEND

- PROPERTY LINE
- - - EXTENT OF UNDERGROUND PARKING (INDICATIVE)
- - - EXTENT OF ROOF / CANOPY LINE (INDICATIVE)
- - - RAIN GARDEN - TOP OF POOL
- - - RAIN GARDEN - BOTTOM OF POOL
- - - EXISTING GRADE (APPROXIMATE)
- - - PROPOSED LANDSCAPE GRADE
- TP TOP OF POOL
- BP BOTTOM OF POOL
- DIRECTION OF FLOW
- RAIN GARDEN ON GRADE
- IMPERVIOUS AREAS
- ROAD / HARDSCAPE DRAINS TO RAIN GARDEN
- RAIN GARDEN

RAIN WATER MANAGEMENT NOTES

Water collected from road areas, building roofs, flow to the rain gardens located throughout the site.

Rain gardens are integrated building landscapes and landscape features that are designed to capture, store, filter, and treat runoff from rooftops, streets, parking lots, and paved areas.

Rain gardens will be designed with underdrains and a high-capacity overflow drain that will be connected to the onsite piped drainage system.

The rain gardens are sized such that the bottom of the rain garden is 5% of the impervious area.


Property line	--- --
Right of Way	---
Extent of Roof, above	---
Extent of Pavement, below	---
Rain garden - TOP OF POOL	---
Rain garden - BOTTOM OF POOL	---
Proposed Contour Line, 0.3m interval	---
Existing Contour Line, 0.3m interval	---

MATERIALS LEGEND	
	Cast in Place Concrete with Decorative Sawcuts Light brown finish, under concrete joints
	Aggregate Surfacing Light brown finish, under concrete joints
	Grass Area Light green finish, under concrete joints
	Synthetic Lawn (Inner Courtyard)
	Planting Area
	Metal Guardrail
	Handrail
	Concrete Retaining Wall
	Trees

SITE FURNISHINGS LEGEND	
	Bicycle Rack, 6 Bicycle capacity Down slope from concrete raised base
	Lounge Chair
	Bench (Wood)
	Picnic Table
	Metal Planter
	Wood Vegetable Garden Box
	Landscape Boulder (To be sourced on site)
	Existing Hydro Pole
	Garage Receptacle

4	DP Re-submission	2023-10-23
3	DP Re-submission	2023-07-26
2	DP Re-submission	2022-11-08
1	DP	11/19/2021
rev no	description	date

77 Chapel Nanaimo, BC	
Project: 77 Chapel 77 Chapel Nanaimo, BC	
Client: Westmark Construction Ltd. 7-2535 16 th Colough Road Nanaimo, BC	
Date: 2023-02-23	
Scale: 1:100 @ 21" x 35"	
Project no: 121.34	
Drawn by: MDI	
Checked by: SM	
Revision:	
Sheet no:	
L1.01	

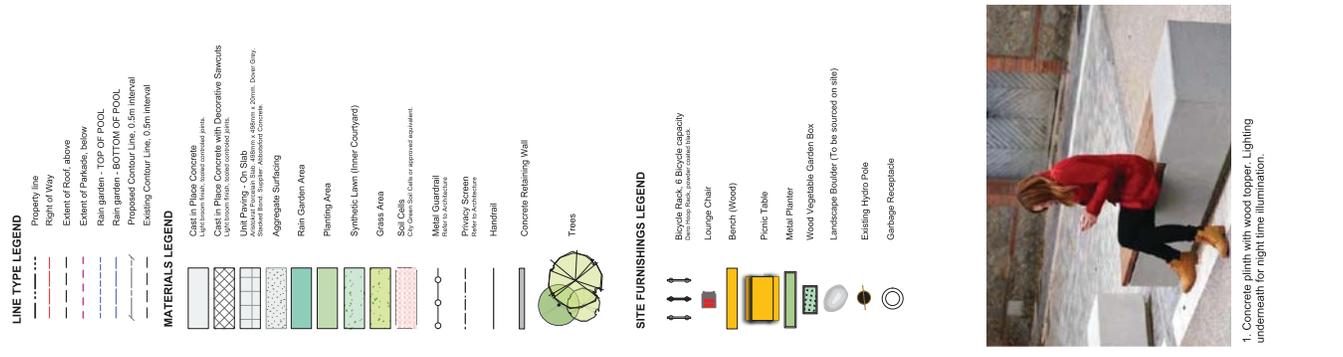

2 Landscape Plan Scale: 1:100

1 Landscape Plan Scale: 1:100

Trained cascading raingardens to filter site runoff and display the process in an interesting manner.

Small Urban Plaza with concrete pinstrip finish and concrete planters for an engraving in center of concrete circle.

Small bermed grassy area, planting and boulders to reflect the regional landscape.

Significant flowering trees to be placed in this area to celebrate this corner.

Small Urban Plaza with concrete pinstrip finish and concrete planters for an engraving in center of concrete circle.



1. Concrete pinstrip with wood topper. Lighting underneath for night time illumination.



LINE TYPE LEGEND

- Property line
- Right of Way
- Extent of Roof, above
- Extent of Terrace, below
- Rain garden - TOP OF POOL
- Rain garden - BOTTOM OF POOL
- Proposed Contour Line, 0.5m interval
- Existing Contour Line, 0.5m interval

MATERIALS LEGEND

- Cast in Place Concrete
- Cast in Place Concrete with Decorative Sawcuts
- Light Brown Brick, 60mm x 120mm
- Light Brown Brick, 60mm x 120mm
- Light Brown Brick, 60mm x 120mm
- Aggregate Surfacing
- Rain Garden Area
- Planting Area
- Synthetic Lawn (Inner Courtyard)
- Grass Area
- Soft Curb
- Metal Guardrail
- Handrail
- Concrete Retaining Wall
- Trees

SITE FURNISHINGS LEGEND

- Bicycle Rack, 6 Bicycle capacity
- Lounge Chair
- Bench (Wood)
- Picnic Table
- Metal Planter
- Wood Vegetable Garden Box
- Landscape Boulder (To be sourced on site)
- Existing Hydro Pole
- Garage Receipts



Wood Bench Seating Embedded Along Concrete Planters

no	no	description	date
4	DP Re-submission	2023-10-23	
3	DP Re-submission	2023-07-26	
2	DP Re-submission	2022-11-08	
1	DP	11/19/2021	


client
Westmark Construction Ltd.
7-2635A Red Clough Road
Nanaimo, BC

project
77 Chapel
77 Chapel
Nanaimo, BC

sheet no.
Landscape Materials

Project no.	121.34
Scale	1:100 @ 24"x36"
Drawn by	MDI
Checked by	SM
Revised by	

Sheet no. **L1.02**

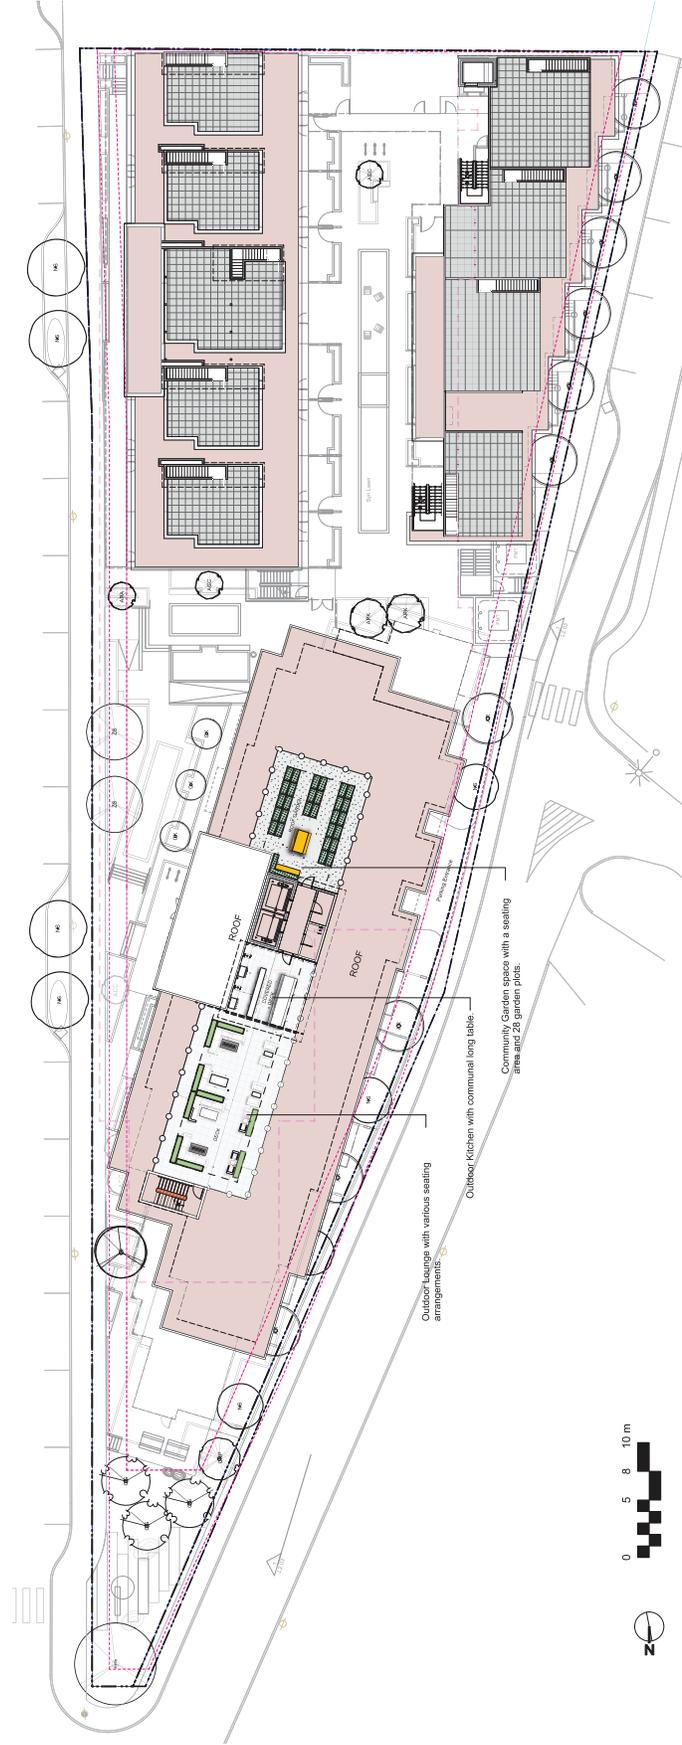

- LINE TYPE LEGEND**
- Property line
 - Right of Way
 - Extent of Roof, above
 - Extent of Pavement, below
 - Rain garden - TOP OF POOL
 - Rain garden - BOTTOM OF POOL
 - Proposed Contour Line, 0.5m interval
 - Existing Contour Line, 0.5m interval

- MATERIALS LEGEND**
- Cast in Place Concrete
 - Cast in Place Concrete with Decorative Sawcuts
 - Lock Paving - On Slab
 - Aggregate Surfacing
 - Rain Garden Area
 - Planting Area
 - Synthetic Lawn (over Courtyard)
 - Grass Area
 - Soil Cells
 - Modular Geotextile
 - Privacy Screen
 - Handrail
 - Concrete Retaining Wall
 - Trees

- SITE FURNISHINGS LEGEND**
- Bicycle Rack, 6 Bicycle capacity
 - Lounge Chair
 - Bench (Wood)
 - Plastic Table
 - Metal Planter
 - Wood Vegetable Garden Box
 - Landscape Boulder (To be sourced on site)
 - Existing Hydro Pole
 - Garbage Receptacle



client: Westmark Construction Ltd.
77-2635 West Colough Road
Nanaimo, BC

Project: 777 Chapel
777 Chapel
Nanaimo, BC

Sheet No: L1.03

Project no:	121.34
Scale:	1:200 @ 21"x35"
Drawn by:	MDI
Checked by:	SM
Revised:	



Rooftop Patio Gathering Space with Seating



Garden Space with Raised Vegetable Planters



LEGEND

- Property line
- Extent of Pavement below
- Rain garden - TOP OF POOL
- Rain garden - BOTTOM OF POOL
- Proposed Contour Line (0.2m interval, typ)
- Existing Contour Line
- Existing Landscape Grade
- Civil Grade, provided for reference only
- Architectural grade, provided for reference only
- Proposed Landscape Grade
 - RV - Bottom of Wall
 - BC - Bottom of Cup
 - BP - Bottom of Pool
 - BS - Bottom of Slab
 - LS - Live Point
 - TP - Top of Terrain
- OK - As Labeled

LANDSCAPE INFRASTRUCTURE

Symbol	Description	Notes
[Swale symbol]	Swale	
[Flow Disperser symbol]	Flow Disperser at RWI/Scupper	
[Rain Garden symbol]	Rain Garden Overflow Drain	
[Landscape Area symbol]	Landscape Area to match adjacent existing landscape (on grade)	
[Clean Out symbol]	Clean Out	
[Perforated Underdrain symbol]	Perforated Underdrain	
[Sched 40 PVC symbol]	Sched 40 PVC	
[Trench Drain symbol]	Trench Drain	Add K100 French Drain, Load Class A1, see notes.
[POC symbol]	Irrigation Point of Connection	See notes.
[Irrigation Valve symbol]	Irrigation Valve	Provide water service and electrical service from irrigation controller to valves.
[Irrigation Sleeve symbol]	Irrigation Sleeve	Install irrigation sleeve, which has 4x 3/4" resin line diameter, for 2" lateral line diameter. Install irrigation wiring in separate 2" electrical conduit, 300mm from part edge of hard surface or walls.
[Mechanical Drains symbol]	Mechanical Drains	(For reference only)

DP	Revised	Description
4	2023-02-23	DP Re-submission
3	2023-01-26	DP Re-submission
2	2022-11-08	DP Re-submission
1	11/19/2021	DP



client: Westmark Construction Ltd., Nanaimo, BC
 Project: 77 Chapel, Nanaimo, BC
 2023-02-23

Project no.	121.34
Scale	1:100 @ 24"x36"
Drawn by	MDI
Checked by	SM
Revision	Sheet no.
L2.01	




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1	DP	11/19/2021
2	DP Reassessment	2023.01.26
4	DP Reassessment	2023.02.23




client: Westmark Construction Ltd. Nanaimo, BC
 Project: 77 Chapel Nanaimo, BC
 Project no: 121.34
 Scale: 1:100 @ A1*50*
 Drawn by: MDI
 Checked by: SM
 Sheet no: L2.02



1 Landscape Elevation
Scale: 1:150

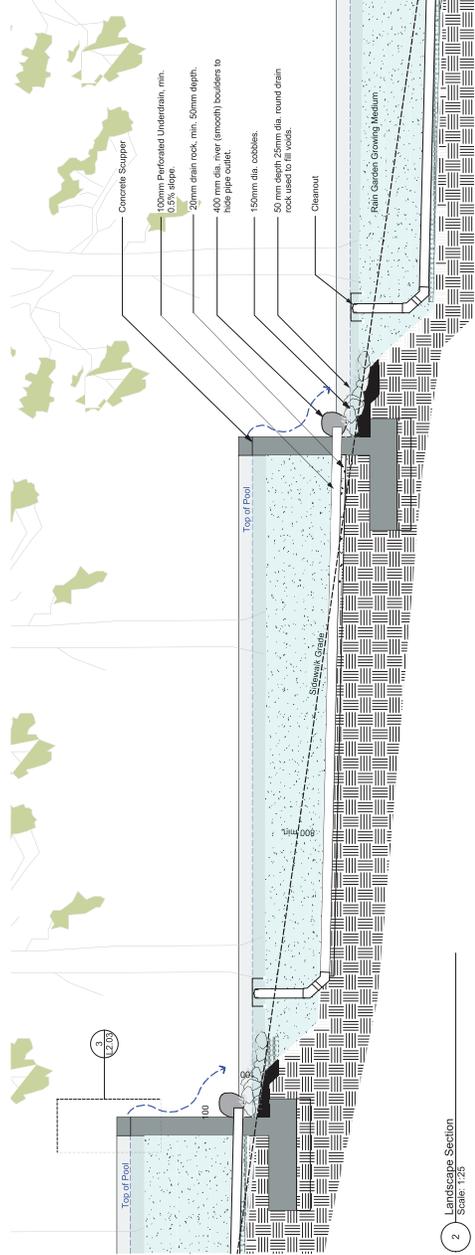

2 Landscape Section
Scale: 1:25

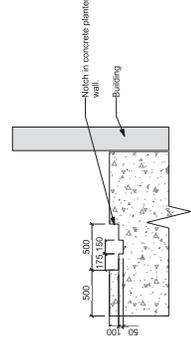

3 Concrete Scupper
Scale: 1:25

4	DP Re-submission	2023-02-23
3	DP Re-submission	2023-01-26
2	DP Re-submission	2022-11-08
1	DP	11/19/2021
rev no.	description	date



client: Westmark Construction Ltd.
77-2535 West Columbia Road
Nanaimo, BC
Project: 77 Chapel
77 Chapel
Nanaimo, BC

Sheet No: L2.03
Project No: 121.34
Scale: N/A @ 21"x35"

drawn by: MDI
checked by: SM
revision: 1

DP	Revised	Date
4	DP Re-submission	2023.02.23
3	DP Re-submission	2023.01.26
2	DP Re-submission	2022.11.08
1	DP	11/19/2021

no	no	description	date
1	1	1	1
2	2	2	2
3	3	3	3
4	4	4	4

Murdoch de Greeff
Landscape Architecture & Planning
2023.02.23

Scott Murdoch
341
Landscape Architecture & Planning
2023.02.23

client: **Westmark Construction Ltd.**
Nanaimo, BC

project: **77 Chapel**
Nanaimo, BC

Project no: 121.24
Scale: 1:100 @ 24"x36"

drawn by: MDI
checked by: SM
revision no: L3.01

Soil Size Plant Spacing

2.4 m x 1.5 m width
4m x 4m, 4m x 5m, 5m x 5m
6.0m x 4.0m, 6.0m x 5.0m, 6.0m x 6.0m

Common Name

Vines: Moon
Japanese Maple
Red Sweetgum
Katsura Tree
Misty Willow
Sawtoothed Oak
Garry Oak
Japanese Zelkova

Latin Name

Acer circinnatum
Acer palmatum
Liquidambar styraciflua
Corylus heterophylla
Magnolia salicifolia
Zelkova serrata

RAIN GARDEN PLANTS

Co-387 Carex concinna
Co-388 Carex acutiflora
Co-389 Carex lasiocarpa
Co-390 Carex flacca
Co-391 Carex lasiocarpa
Co-392 Carex flacca
Co-393 Carex lasiocarpa
Co-394 Carex flacca
Co-395 Carex lasiocarpa
Co-396 Carex flacca
Co-397 Carex lasiocarpa
Co-398 Carex flacca
Co-399 Carex lasiocarpa
Co-400 Carex flacca



1. Rain gardens with mixed shrub and perennial plantings and trees.
2. Significant flowering trees to be the focal point and celebration of this corner.
3. Naturally planted landscape with embedded boulders.



REFER TO L3.01 FOR PLANT LIST.



1. Concrete planters with shrubs plantings and trees.



2. Synthetic lawn in private courtyard for relaxing, social gathering, or casual play.



client	Westmark Construction Ltd. 17-2635 Mc Clellough Road Nanaimo, BC	
project	77 Chapel Nanaimo, BC	
sheet no.	Planting Plan	
project no.	121.34	
scale	1:100 @ 24"x36"	
drawn by	MDI	
checked by	SM	
revision no.	Sheet no.	
		L3.02