

DEVELOPMENT PERMIT NO. DP001235

BARRINGTON TOWNHOMES LTD Owner(s) of Land (Permittee)

3401 BARRINGTON ROAD Civic Address

- 1. This development permit is issued subject to compliance with all of the bylaws of the municipality applicable thereto, except as specifically varied or supplemented by this permit.
- 2. This development permit applies to and only to those lands within the municipality described below, and any and all buildings, structures and other developments thereon:

Legal Description:

LOT 2, DISTRICT LOT 56, WELLINGTON DISTRICT, PLAN EPP47501, **EXCPET PLAN VIS3935 (PHASE 4)** PID No. 029-659-167

3. The land described herein shall be developed strictly in accordance with the following terms and conditions and provisions of this permit and any plans and specifications hereto which shall form a part thereof.

Schedule A Subject Property Map Schedule B Master Site Plan Schedule C Site and Parking Plans

Schedule D Building Elevations and Details

- Schedule E Landscape Plan and Details
- 4. If the landowner does not substantially start any construction with respect to which this permit was issued within two years after the date it was issued, the permit lapses.
- 5. This permit is not a building permit nor does it constitute approval of any signage. Separate applications must be made for a building permit and sign permit.
- This permit prevails over the provisions of the bylaw in event of conflict. 6.

TERMS OF PERMIT

The "City of Nanaimo Zoning Bylaw 2011 No. 4500" is varied as follows:

- Section 6.10.2 Fence Height to increase the maximum allowable height for a 1. combined retaining wall and fence from 2.4m to 5.2m within the side yard, and from 3.0m to 5.2m outside of the required setbacks.
- 2. Section 7.6.1 Size of Buildings – to increase the maximum allowable building height from 9m to:
 - Building 1 9.8m
 - Building 5 9.7m
 - Building 7 10.4m

CONDITIONS OF PERMIT

- 1. The subject property is developed in accordance with the Site and Parking Plans prepared by G3 Architecture Inc., dated 2023-MAY-17, as shown on Schedule C.
- 2. The development is in substantial compliance with the Building Elevations and Details prepared by G3 Architecture Inc., dated 2023-MAY-12 respectively, as shown on Schedule D.
- 3. The subject property is developed in substantial compliance with the Landscape Plan and Details prepared by Architecture Panel Inc., dated 2023-MAY-19, as shown on Schedule E.
- 4. Installation of high-visibility fencing is to be installed prior to Building Permit issuance to protect areas of natural vegetation proposed for retention.

AUTHORIZING RESOLUTION PASSED BY COUNCIL THE 10TH DAY OF JULY, 2023.

August 4, 2023


Corporate Officer

Sheila Gurrie

Corporate Officer City of Nanaimo

Prospero attachment: DP001235

SR/bb

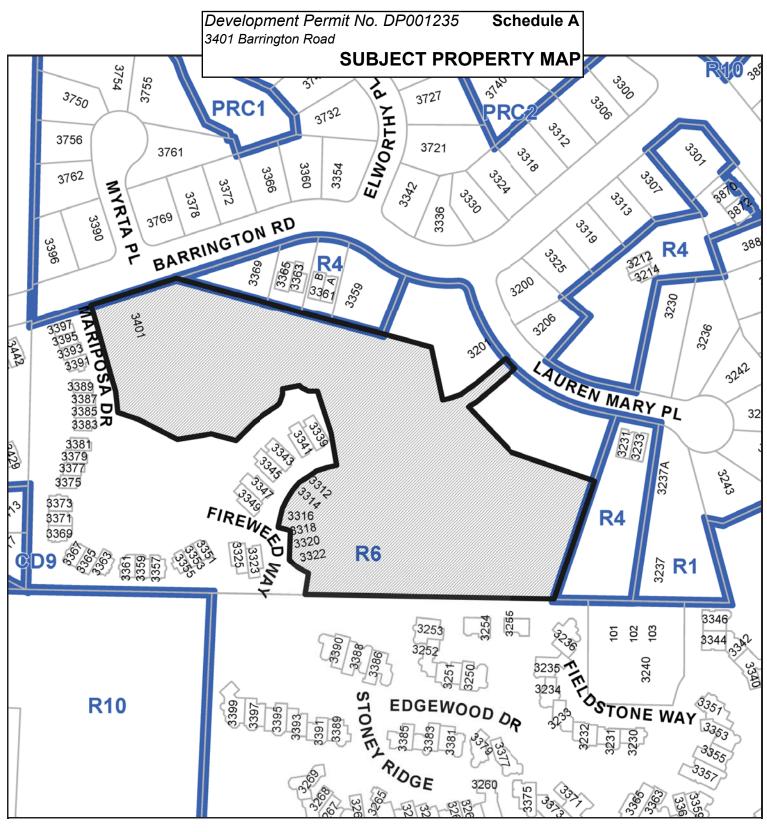




Development Permit No. DP001235 Schedule B 3401 Barrington Road


MASTER SITE PLAN

BUILDING HEIGHTS		
BLOCK #1		
AVERAGE FINIHSED GRADE		
(133.147+133.147+136.494+136.494)/4 =	442.32 FT	134.82 M
PROPOSED BUILDING HEIGHT ELEVATION =	474.38 FT	144.59 M
PROPOSED BUILDING HEIGHT =	32.05 FT	9.77 M
BLOCK #2		
AVERAGE FINIHSED GRADE		
(130.254+131.300+134.000+133.401)/4 =	433.86 FT	132.24 M
PROPOSED BUILDING HEIGHT ELEVATION =	461.58 FT	140.69 M
PROPOSED BUILDING HEIGHT =	27.72 FT	8.45 M
BLOCK #3		
AVERAGE FINIHSED GRADE		
(135.636+136.652+139.999+138.983)/4 =	457.28 FT	139.38 M
PROPOSED BUILDING HEIGHT ELEVATION =	485.86 FT	148.09 M
PROPOSED BUILDING HEIGHT =	28.58 FT	8.71 M
BLOCK #4		
AVERAGE FINIHSED GRADE		
(132.300+133.769+137.500+136.347)/4 =	442.85 FT	134.98 M
PROPOSED BUILDING HEIGHT ELEVATION =	471.26 FT	143.64 M
PROPOSED BUILDING HEIGHT =	28.41 FT	8.66 M
BLOCK #5		
AVERAGE FINIHSED GRADE		
(137.26+138.074+141.421+140.609)/4 =	458.76 FT	139.83 M
PROPOSED BUILDING HEIGHT ELEVATION =	490.55 FT	149.52 M
PROPOSED BUILDING HEIGHT =	31.79 FT	9.69 M
BLOCK #6		
AVERAGE FINIHSED GRADE		
(133.850+134.600+138.760+137.846)/4 =	447.05 FT	136.26 M
PROPOSED BUILDING HEIGHT ELEVATION =	475.16 FT	144.83 M
PROPOSED BUILDING HEIGHT =	28.12 FT	8.57 M
BLOCK #7		
AVERAGE FINIHSED GRADE		
(138.633+139.649+142.996+141.777)/4 =	461.81 FT	140.76 M
PROPOSED BUILDING HEIGHT ELEVATION =	495.70 FT	151.09 M
PROPOSED BUILDING HEIGHT =	33.89 FT	10.33 M
PROPOSED VARIANCES TO THE MAXIMUM ALLO' OF 9.0M ARE AS FOLLOWS:	WABLE BUILDING	G HEIGHT
	SED HEIGHT VA SED HEIGHT VA SED HEIGHT VA SED HEIGHT VA SED HEIGHT VA	RIANCE = NONE RIANCE = NONE RIANCE = NONE RIANCE = 0.69M RIANCE = NONE

	86,855.4 SF	8,069.13 SM
40.0%	34 742 2 SE	3 227 65 SM
	3,397.5 SF	315.64 SM
	4,810.9 SF	446.95 SM
	2,565.7 SF	238.36 SM
	4,810.9 SF	446.95 SM
	2,565.7 SF	238.36 SM
	4,810.9 SF	446.95 SM
	3,397.5 SF	315.64 SM
30.3%	26,359.1 SF	1,000.95 SM
		3,397.5 SF 4,810.9 SF 2,565.7 SF 4,810.9 SF 2,565.7 SF 4,810.9 SF 3,397.5 SF

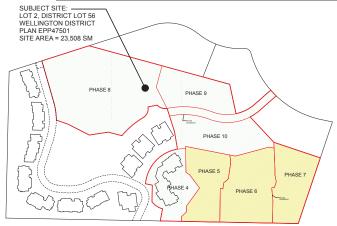

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MASTER SITE PLAN (FAR)	TOTAL SITE AREA = (PHASE 4 TO 10)	253,046.2 SF	23,508.8 SM
(N.T.S. FOR REFERENCE ONLY)	MAXIMUM ALLOWABLE FAR @ 0.45 =	113,870.8 SF	10,578.9 SM
	PROPOSED FLOOR AREA (PHASE 5) =	13,235.6 SF	1,229.6 SM
	PROPOSED FLOOR AREA (PHASE 6) =	16,464.7 SF	1,529.6 SM
	PROPOSED FLOOR AREA (PHASE 7) =	13,170.7 SF	1,223.6 SM
TOTAL PROF	POSED FLOOR AREA (PHASE 5, 6, & 7) =	42,871.0 SF	3,982.8 SM
FLOOR AREA	ALREADY USED IN PHASE 4 (DP1116) =	11,751.3 SF	1,091.7 SM
EXISTING AND PROPOSED TO	OTAL FLOOR AREA (PHASE 4, 5, 6, & 7) =	54,622.3 SF	5,074.6 SM
	PROPOSED FAR = (LESS THAN MAX. 0.45 ALLOWED)	0.22	

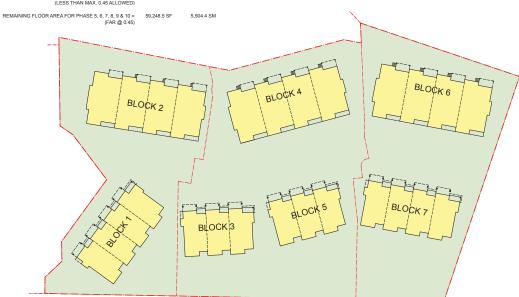



KEY SITE PLAN (N.T.S. FOR REFERENCE ONLY) SUBJECT SITE (PHASES 5 & 6 & 7) AREA = 7,954.9SM (85,629SF)

19/11/01	DESIGN DEVELOPMENT
20/05/10	DEVT PERMIT COORDINATION
20/12/05	ISSUED FOR DP: PRE-APPLICATION
21/04/12	ISSUED FOR DEVT PERMIT APPLICATION
21/08/27	REVD PER DAP COMMENTS
22/10/25	REVD PER FORM E & COMP. LETTER 21/12/01
22/11/06	MINOR REVISIONS / CLARIFICATIONS
23/02/24	ADD SIDEWALK, REVISE BLDG LOCATIONS
23/05/12	REVISED AND REISSUED FOR DEVT. PERMIT



G3 ARCHITECTURE INC #130 - 1959 - 152ND STREET SURREY, B.C.

TEL: 604-916-8582 EMAIL: gus@g3projects.com



26 UNIT TOWNHOUSE DEVELOPMENT 3401 BARRINGTON ROAD NANAIMO, BC


DEVELOPMENT PERMIT #DP001235


KEY SITE PLAN AREA SUMMARY

DP1235 2023-MAY-17 BUILDING HEIGHT SUMMARY

RECEIVED

	DAWING NO.:
23/05/12	A100

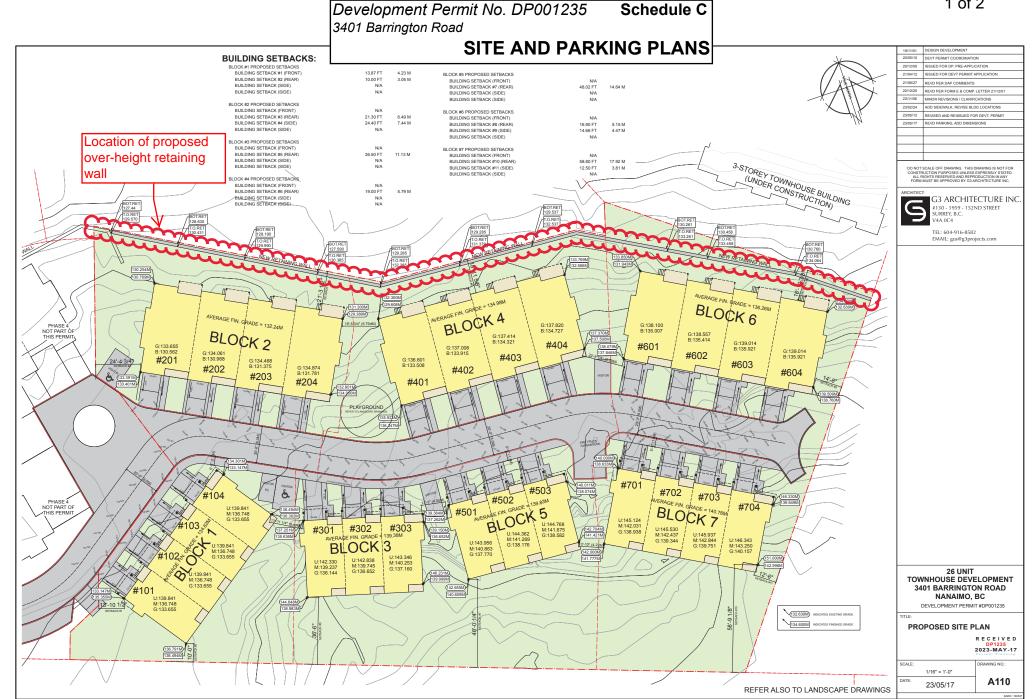

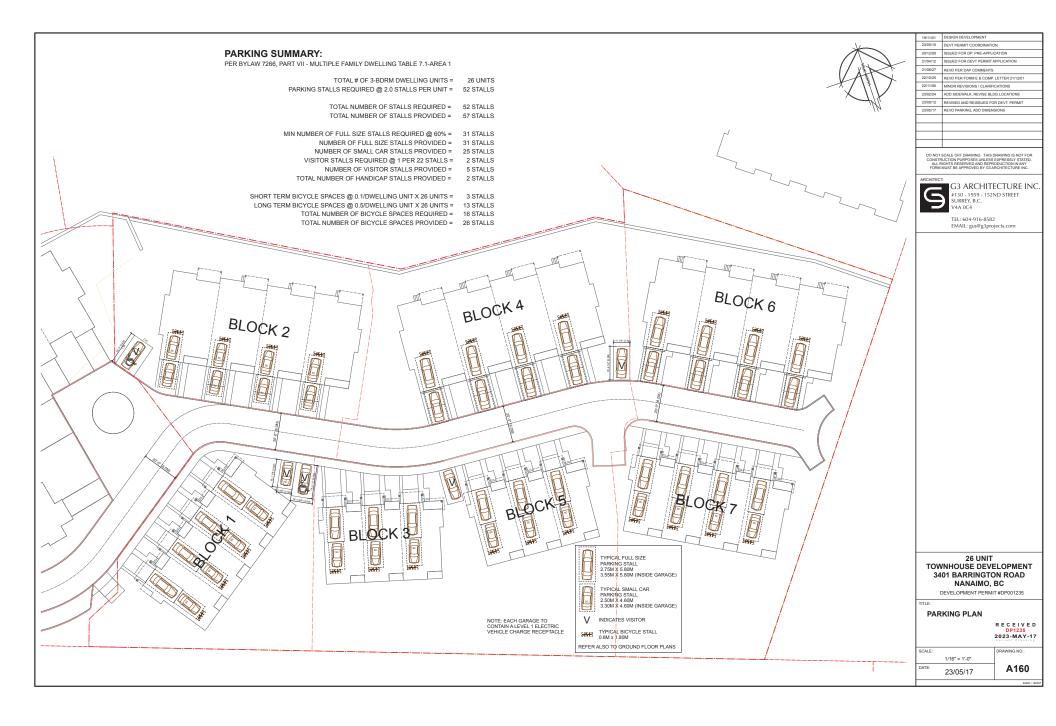

Development Permit No. DP001235 3401 Barrington Road

Schedule D

BUILDING ELEVATIONS AND DETAILS



-BLOCK 1

AERIAL VIEW FROM NORTHWEST

AERIAL VIEW FROM NORTHEAST



FRONT AND SIDE (WEST END) OF BUILDING

BLOCK 1

SITE SECTION (SCHEMATIC)



FRONT AND SIDE (EAST END) OF BUILDING



Maximum permitted building height



REAR OF BUILDING (SOUTH)




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BLOCK #1 AVERAGE FINIHSED GRADE

(133.147+133.147+136.494+136.494)/4 = PROPOSED BUILDING HEIGHT ELEVATION = 474.38 FT 144.59 M PROPOSED BUILDING HEIGHT = 32.05 FT 9.77 M 26 UNIT TOWNHOUSE DEVELOPMENT FIREWEED WAY NANAIMO, BC

DEVELOPMENT PERMIT #DP001235

BLOCK 1 BUILDING ELEVATIONS SITE SECTION

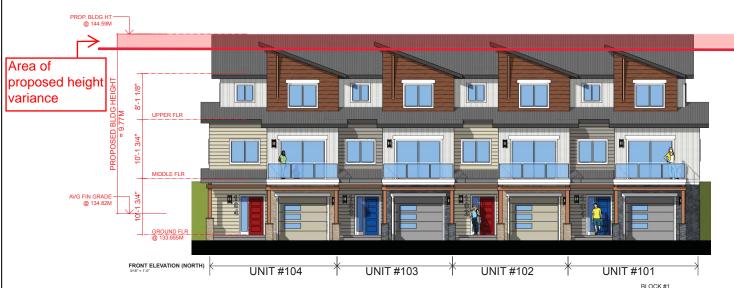AS SHOWN A300 23/05/12

2023-MAY-17















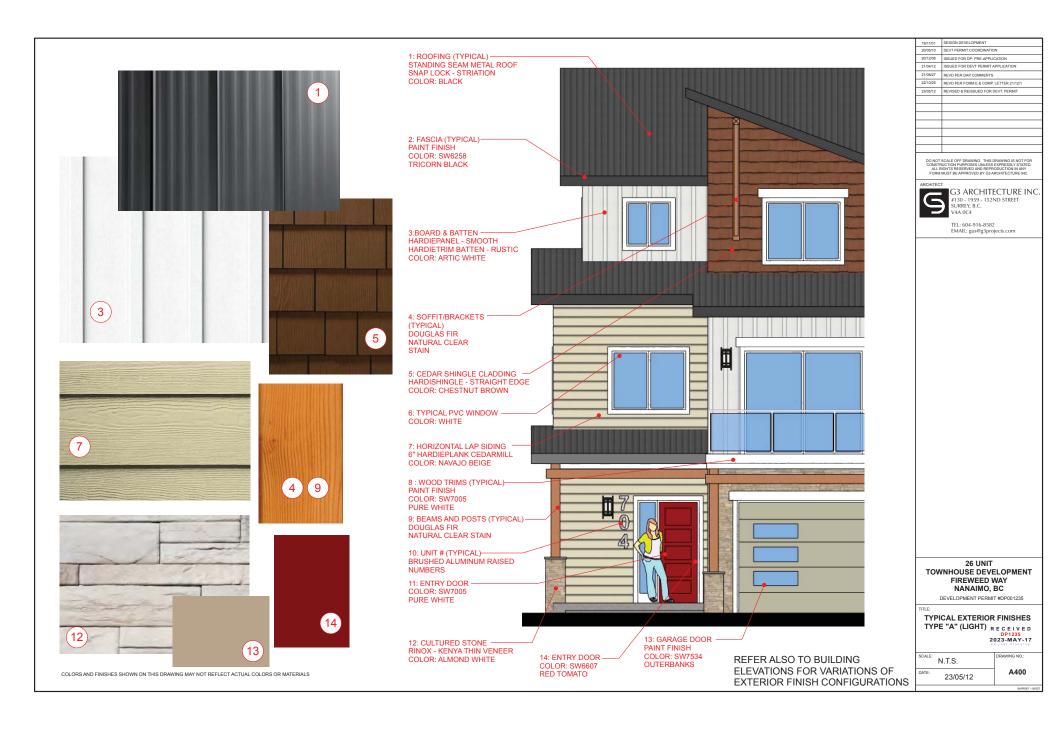

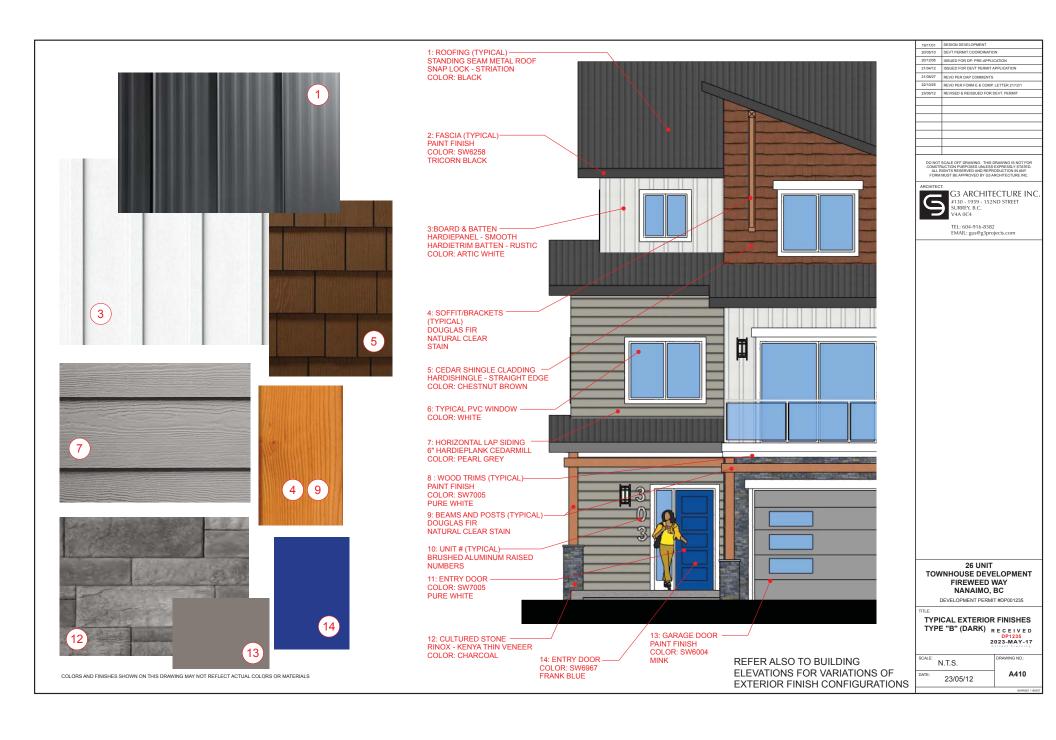

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LANDSCAPE PLAN AND DETAILS

Schedule E



DESIGN RATIONALE AND SUMMARY

The topography in this project adds character to the landscape which can be visible for residents from the private patios and balconies on the front and rear ends of the units.in addition to the sloping terrain, the building layouts create wedged spaces between buildings which are proposed to be filled with a pallette of vibrant plants, creating unique and interesting experience that can be enjoyed by residents in each of such wedges.

Units in blocks (1,3,5,7) have south facing patios and grass yard overlooking the rock face and an uphill layered landscape with varying trees, shrubbery and meadows. The grassed yards are also proposed to be divided by rock walls and a shrubbery buffer to create a more defined and private space for each unit.

Units in blocks (2,46) have a south facing front yard maintained by low shrubs and a privacy screen, as well as private elevated north facing patios that are also proposed to be separated with a privacy screen and a small garden area.

The amenity space, surrounded by shade and flowering trees offer different seating options, benches in addition to a playground set with play equipments. The surface treatment of the proposed hardscape are used to establish the movement hierarchy as well as the wayfinding in the complex. The southern edge of the complex is lined with an afforested ridge of conifers which are carefully punctuated in the foreground by the columnar deciduous trees acting as focal elements.

The northern edge of the complex is protected by a continuous retaining wall that is proposed to be treated with a hardy and vibrant surface climbing 'Boston Ivy'.

GENERAL NOTES

All materials and workmanship to CLS Standards, latest edition. Soil depths and subgrade preparation, soil quality and plant sizes to meet or exceed that standard. The installers are advised to search and review, make plant material available to the Landscape Architect for optional review at the source of supply. Area of search to include Lower Mainland and Fraser Valley. 'Substitutions' must obtain written approval from the Landscape Architect prior to making any substitutions to specified material. Unapproved substitutions will be rejected. Allow a minimum of five working days prior to delivery for request to substitute. Substitutions are subject to the Landscape Standard.

All plant material must be provided from the certified 'Disease Free' nursery. All plant material must conform to the latest edition of the 'BC Landscape Standard'. Provide certification upon request. All landscaping and landscape materials to conform to the latest edition of the BCLNA/BCSLA standards.

Min. growing medium depths over prepared subgrade shall be:

 Lawn areas
 300mm

 Ground Cover Areas
 450mm

 Shrub Areas
 450mm

ree Pits 300mm (around root balls)

Growing medium shall have physical and chemical properties as described in the standards for 'Ground'areas, except for the areas over structures where the medium shall conform to the requirements for level 1 applications. Processing and mixing of the growing medium shall be done off-site using a mechanized screening process. Proposed growing medium shall be tested by a recognized laboratory. The contractor shall guarantee that the soil submitted for testing is a sample representative of the soil to be used at the site.

On-Site or imported soils shall satisfy the requirements of the standards for growing medium. Soils shall be virtually free from subsoil, wood including woody plant parts, weed or reproducive parts of the weeds, plant pathogenic organisms, toxic material, stones over 30mm, and foreign objects.

All planting beds shall receive min. 50mm bark mulch. The contractor shall maintain clean working conditions, remove all refuse and debris present the site in a safe and clean condition upon completion of all works. Plant species and varieties may not be substituted without the approval of the Landscape architect. All wood fences to be cedar, with one coat of clear penetrating preservative.

R E C E I V E D DP1235 2023-JUN-21



ARCHITECTURE PANEL INC.

STECTURE I LANDSCARE ARCHITECTURE I LIDRAN DE

Unit 103, 15505 Marine Drive, Whiterock, BC 6047831450 | ruchir@architecturepanel.com

Acrhitects's written consent.

These Drawings and the design are and at all times remain the exclusive property of Architecture Panel Inc. and cannot be used without the Landscape

Contractor is responsible for verification of all dimensions, elevations and other datum an drawings. Any discrepencies to be reported immediately to the Landscape Architect. Any changes made without the Landscape Architects written consent shall be the contractor's sole responsibility. Do not scale drawings. Dimensions govern.

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Project 26 UNIT TOWNHOUSE DEVELOPMENT FIREWEED WAY

Owner Bill Beadle

AHI

City of Nanaimo

Sheet Title KEY PLAN Total Sheets Sheet No. 5 L1 Drawn By Checked By SSS SD Reviewed By Status RD DP Application Contractors Consultants G3 ARCHITECTURE INC.

No	Date	Issue Notes
A	2021-03-17	DP Application
В	2021-09-10	Re-issued for DP Application
C	2022-01-21	Re-issued for DP Application
D	2022-11-29	Re-issued for DP Application
E	2023-04-14	Re-issued for DP Application
F	2023-05-19	Review and for DP Application

Documents







Scale: 1:48



ARCHITECTURE PANEL INC.

ARCHITECTURE | LANDSCAPE ARCHITECTURE | URBAN DESIGN

Unit 103, 15505 Marine Drive, Whiterock, BC 6047831450 | ruchir@architecturepanel.com

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26 UNIT TOWNHOUSE DEVELOPMENT FIREWEED WAY

Total Sheets	Sheet No.
5	L2
Drawn By	Checked By
SSS	SD
Reviewed By	Status
RD	DP Application
Contractors	Consultants
	G3 ARCHITECTURE INC.

AHJ	Documents
City of Nanaimo	

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E	2023-04-14	Re-issued for DP Application
F	2023-05-19	Re-issued for DP Application
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15 Vaccinium ovatum 'Thunderbird'

