

DATE OF MEETING | June 1, 2020

AUTHORED BY | LISA BRINKMAN, PLANNER, CURRENT PLANNING

SUBJECT | **DEVELOPMENT PERMIT APPLICATION NO. DP1182 –
380 COTTLE PLACE**

OVERVIEW

Purpose of Report

To present for Council's consideration a development permit renewal application for a multi-family, steep-slope development consisting of 8 single detached and 16 townhouse units.

Recommendation

That Council issue Development Permit No. 1182 at 380 Cottle Place with the following variances:

- increase the maximum allowable building height from 7m up to 9.5m, as outlined in the development permit; and
- increase the maximum allowable perimeter wall height from 7.32m to 8.96m, as outlined in the terms of the development permit.]

BACKGROUND

A development permit application, DP1182, was received from Modev Construction Ltd. on behalf of Bethel Lands Corporation Ltd. for a proposed development consisting of 24 multi-family residential units on a steep-slope site. This application is to renew DP1074, which was issued by Council on 2018-FEB-18. There have been no changes to the proposed development since DP1074 was approved; however, the permit has expired and the applicant wishes to renew the permit as they are ready to proceed with the project. The allowable density for the 1.7ha property is 16 units per hectare, to a maximum of 27 units. The permitted floor area ratio is 0.45; the proposed floor area ratio is 0.39.

Subject Property and Site Context

Zoning	R10 – Steep Slope Residential
Location	The subject property is accessed from the Cottle Place cul-de-sac in the Nottingham Drive area of the Linley Valley neighbourhood.
Total Area	1.7 ha
Official Community Plan (OCP)	Map 1 – Future Land Use Plan – Neighbourhood; Map 3 – Development Permit Area No. 5 – Steep Slope Development; and, Map 3 – Development Permit Area No. 9 - Commercial, Industrial, Institutional, Multiple Family and Mixed Commercial/Residential Development.
Relevant Design Guidelines	Steep Slope Development Permit Guidelines General Development Permit Design Guidelines

The subject property is vacant and is surrounded by single family residential dwellings in a steep-slope setting. The north property line abuts Nottingham Drive Park. The natural features of the site include rock outcrops, exposed rock knolls, steep slopes, and small groupings of urban forest.

DISCUSSION

Proposed Development

The subject application is to renew the original development permit (DP1074) for a 24-unit residential strata development comprised of 8 single detached units and 16 townhouse units. There have been no changes to the proposed development since it was approved by Council on 2018-FEB-18. The townhouse units range in size from 263m² to 368m². The single units range in size from 193m² to 264m².

Site Design

The townhouse units are clustered into groups consisting of five duplexes and two tri-plexes. The site layout is designed to respect the topography of the property and to minimize site disturbance. The townhouse unit clusters are stepped to work with the site grades and to maintain views between the clusters.

In accordance with the Steep Slope Design Guidelines, the single units are sited behind the ridgeline to preserve the ridgeline and associated rock knolls. An environmental assessment was provided that identified sensitive site features, including rock ledges, undulating rock slopes covered in moss, and native vegetation. The siting of the buildings is designed to minimize impact to these sensitive site features.

A Comprehensive Preservation Plan has been established to ensure long-term preservation of the sensitive site features, including the installation of split-rail fencing to deter access and disturbance of these areas, and informative signage to communicate the value of the sensitive areas.

The proposed internal strata road alignment follows the site contours to minimize site disturbance in accordance with the Steep Slope Design Guidelines. There is also an existing access easement along the west edge of 360 Cottle Place, which provides access to the detached garages of townhouse Units 1 and 2.

Building Design

The townhouse units each have a modern flat roof, two-storey living space, and an under-the-building two-car garage. Townhouse Units 1, 2, 15 and 16 are exceptions, with detached garages to allow the townhouse clusters to fit the existing site conditions with reduced site disturbance.

The single units are two storeys in height, with a modern flat roof, and each unit has a two-car garage. The upper floors of the single units (Units 1 – 7) are set back from the lower floors, which reduces the scale of the building form, as well as the exposure of the single units from behind the ridgeline.

The proposed exterior finishes, roof projections, and overhangs provide articulation to reduce the vertical and horizontal massing of the structures. The finishes include smooth stucco with metal reveals, cedar siding, and stone veneer. The patios are finished with glass panels. Additional exterior features include a wood trellis and wood-panelled garage doors on each unit. The proposed building design and massing are in compliance with the General Design Guidelines.

Landscape Design

The proposed landscape plan builds on the natural environment of the site and provides retaining walls of natural stone, exposed rock outcrops, and stone stairs to accent the existing site conditions. The trees to be retained on the property are a feature of the landscape design, and will contribute to maintaining the character of the property.

The storm water management features are arranged to provide function and an aesthetic treatment onsite, including two detention ponds, and bio-swales that are designed to create the appearance of a streambed.

One pathway is proposed to provide connectivity for residents from the subject property to the park located on the north edge of the property. The path route follows existing alignment of an informal footpath. Benches are located with appropriate lighting along the internal pathways. The steep ridgeline is delineated with a split-rail fence to demarcate the protected areas.

A proposed pavilion is located to the north of Unit 3, with a trail connection to the internal road and stone steps to the structure. The pavilion provides an onsite amenity and is constructed of materials that are complementary to the units, including cedar timber, stone columns, and flagstone.

Proposed Variances

Maximum Allowable Building Height

Variances to the maximum allowable building height are proposed as follows:

Single Units:

Unit Number	Maximum Allowable Height	Proposed Height	Proposed Height Variance
1	7m	7.7m	0.7m
2	7m	7.8m	0.8m
3	7m	7.5m	0.5m
4, 6	7m	7.6m	0.6m
5	7m	7.1m	0.1m
7	7m	8.4m	1.4m
8	7m	7.9m	0.9m

The single units have a modern flat roof, are stepped back from the ridgeline, and are situated at the lowest elevation of the site to reduce their visual prominence. Despite the need for variances, the single units will be approximately 10 to 20m below the elevations of the existing residences located to the south along Canterbury Crescent. As a result, the existing residences will maintain views over the roofs of the new units.

Townhouse Units:

Unit Number	Maximum Allowable Height	Proposed Height	Proposed Height Variance
1, 2	7m	8.7m	1.7m
6, 7	7m	8.7m	1.7m
8, 9	7m	8.7m	1.7m
3,4,5	7m	9.5m	2.5m
10,11	7m	8.4m	1.4m
12,13,14	7m	8.8m	1.8m
15,16	7m	7.3m	0.3m

The townhouse buildings have a stepped modern flat-roof design and are strategically sited to minimize view impacts for adjacent properties. The flat-roof design maximizes the view plane.

The townhouse cluster with Units 1 and 2 will be screened from adjacent residences (to the west and north) by an existing stand of trees, which is to be retained as part of the site features. Overlook is reduced as the primary outdoor living area is oriented to the water view (north side).

The two townhouse clusters with Units 6/7 and Units 8/9 have stepped flat roofs and are sited to ensure sightlines/views are preserved over the roofs and between the townhouse clusters.

The maximum height of a principal building is 7m for a flat roof with a pitch of less than 4:12. The proposed building heights of the units range from 7.1m up to 9.5m; variances up to 2.5m. The increase in the height of the units allows the design to respond to the topography of the site. For example, townhouse Units 3/4/5, with a maximum varied height of 9.5m, are located within a low area of the subject property and step down with the existing grade. The proposed heights will not negatively impact the views of the upslope properties, which are situated approximately 7m above the subject property.

Maximum Perimeter Wall Height

Variances to the maximum perimeter wall height are proposed as follows:

Single Unit:

Unit Number	Maximum Allowable Height	Proposed Height	Proposed Height Variance
6	7.32m	8.30m	0.98m

Townhouse Units:

Unit Number	Maximum Allowable Height	Proposed Height	Proposed Height Variance
1	7.32m	8.96m	1.64m
2	7.32m	8.29m	0.97m
3	7.32m	8.96m	1.64m
9	7.32m	7.89m	0.57m
14	7.32m	7.46m	0.14m

The maximum allowable perimeter wall height is 7.32m. The proposed perimeter wall heights of the townhouse units range between 7.46m to 8.96m, with variances up to 1.64m. The proposed perimeter wall height of Unit 6 is 0.98m. The building designs respond to the topography of the site and are well articulated, with stepped building faces, horizontal rooflines, and glazing to reduce the massing.

Staff support the proposed variances.

SUMMARY POINTS

- Development Permit Application No. DP1182 proposes to renew DP1074 for a steep-slope multi-family residential development, with 8 single detached and 16 townhouse units at 380 Cottle Place.
- There have been no changes to the development since DP1074 was issued, and the proposed development meets the intent of the Steep Slope Design Guidelines and General Design Guidelines.
- Staff support the proposed building height and perimeter wall height variances.

ATTACHMENTS

- ATTACHMENT A: Permit Terms and Conditions
ATTACHMENT B: Location Plan
ATTACHMENT C: Site Plans
ATTACHMENT D: Cross Sections
ATTACHMENT E: Ridgeline View
ATTACHMENT F: Building Elevations
ATTACHMENT G: Building Material Finishes
ATTACHMENT H: Landscape Plans and Details
ATTACHMENT I: Aerial Photo

Submitted by:

Lainya Rowett
Manager, Current Planning

Concurrence by:

Jeremy Holm
Director, Development Approvals

Jeremy Holm for Dale Lindsay
General Manager, Development Services |

ATTACHMENT A **PERMIT TERMS AND CONDITIONS**

TERMS OF PERMIT

The “City of Nanaimo Zoning Bylaw 2011 No. 4500” is varied as follows:

1. *Section 7.6.1 – Size of Buildings* – to increase the maximum allowable building height as follows:

Single Units:

Unit Number	Maximum Allowable Height	Proposed Height	Proposed Height Variance
1	7m	7.7m	0.7m
2	7m	7.8m	0.8m
3	7m	7.5m	0.5m
4, 6	7m	7.6m	0.6m
5	7m	7.1m	0.1m
7	7m	8.4m	1.4m
8	7m	7.9m	0.9m

Townhouse Units:

Unit Number	Maximum Allowable Height	Proposed Height	Proposed Height Variance
1, 2, 6, 7, 8, 9	7m	8.7m	1.7m
3,4,5	7m	9.5m	2.5m
10,11	7m	8.4m	1.4m
12,13,14	7m	8.8m	1.8m
15,16	7m	7.3m	0.3m

2. *Section 7.6.6 – Size of Buildings* – to increase the maximum perimeter wall height as follows:

Single Unit:

Unit Number	Maximum Allowable Height	Proposed Height	Proposed Height Variance
6	7.32m	8.3m	0.98m

Townhouse Units:


Unit Number	Maximum Allowable Height	Proposed Height	Proposed Height Variance
1	7.32m	8.96m	1.64m
2	7.32m	8.29m	0.97m
3	7.32m	8.96m	1.64m
9	7.32m	7.89m	0.57m
14	7.32m	7.46m	0.14m

CONDITIONS OF PERMIT

1. The subject property is developed generally in accordance with the Site Plans prepared by Hillel Architecture received 2020-APR-02 as shown on Attachment C.

2. The development is in accordance with the Cross Sections and Ridgeline View prepared by Hillel Architecture received 2020-APR-02 as shown on Attachments D and E.
3. The development is in accordance with the Building Elevations prepared by Hillel Architecture received 2020-APR-02 as shown on Attachment F.
4. The development is generally in accordance with the Building Material Finishes prepared by Hillel Architecture received 2020-APR-02 as shown on Attachment G.
5. The development is in general compliance with the Landscape Plans and Details prepared by MacDonald Gray received 2020-APR-02 as shown on Attachment H.
6. The subject property is developed and maintained in accordance with the recommendations contained in the Bioinventory Assessment prepared by Toth and Associates Environmental Services dated July 2017; and, the Preservation Areas plan received from Modev Construction Ltd. on 2020-APR-02.

**ATTACHMENT B
LOCATION PLAN**

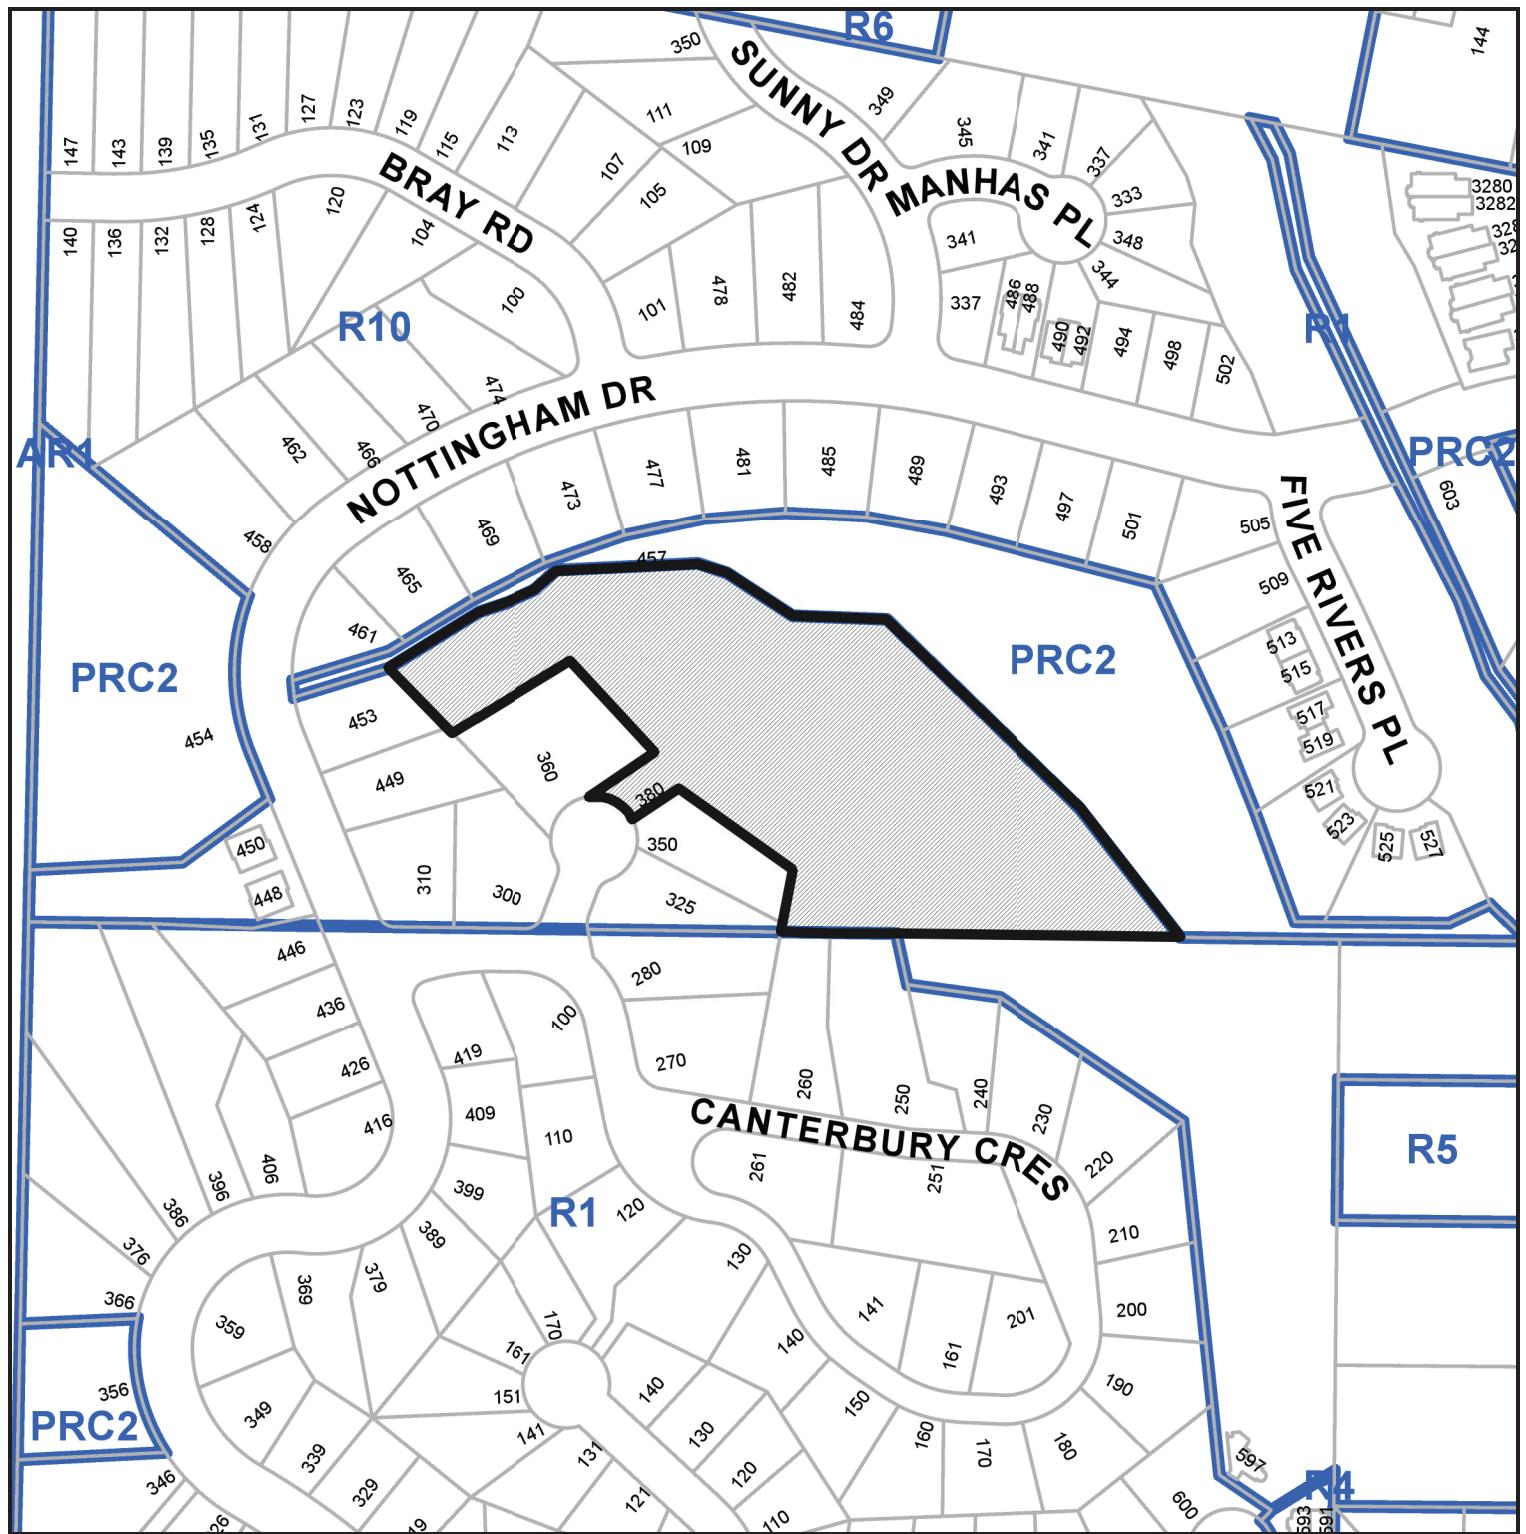

DEVELOPMENT PERMIT NO. DP001182



Subject Property

CIVIC: 380 COTTLE PLACE

LEGAL: LOT 8, SECTION 15A, WELLINGTON DISTRICT, VIP83210





380 COTTLIE PLACE

Development Permit Application
The ridgeline of Cottle Place,

Nanaimo, British Columbia





380 COTTLER PLACE

Development Permit Application

The ridgeline of Cottle Place,
380 Cottle Place,
Nanaimo, British Columbia

Development Permit Application	
September 21, 2017	
Project Revision	
Response to City of	
Nanaimo Review	
February 1, 2018	
380 Cottle Place	
Advanced Development Permit Submission	
380 Cottle Place, Nanaimo, British Columbia	
Project:	Waverly 100.
Planning Element:	A1.3
Site and Grading Plan 2	
Planning Element:	Site
Drawing #10	
<small>For your reference, the original drawing is located at the top of the page. This copy has been reduced in size and may not be suitable for reproduction. If you require a larger copy, please contact the City of Nanaimo at 250-598-4200 or email info@nanaimo.ca.</small>	

R E C E I V E D
DP1182
2020-APR-02

ATTACHMENT D CROSS SECTIONS

1 of 2

360 Cottle Place



350 Cottle Place



SF 03

SF 02



TH 09



Development Permit Application September 21, 2017 Project Revision Request Date: December 7th, 2017	
380 Cottle Place 380 Cottle Place, Nanaimo, British Columbia	
Project Sections	
Section:	380 Cottle Place
Comments:	Site plan, Nutrients, Soil Contamination
Attachment:	Site plan, Nutrients, Soil Contamination
Comments:	Site plan, Nutrients, Soil Contamination
Attachment:	Site plan, Nutrients, Soil Contamination

Hill[e]

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380 COTTLE PLACE
Development Permit Application
The ridgeline of Cottle Place, 380 Cottle Place, Nanaimo, British Columbia

mōdev
263729194 stonewall@mōdev.ca
mōdev.ca

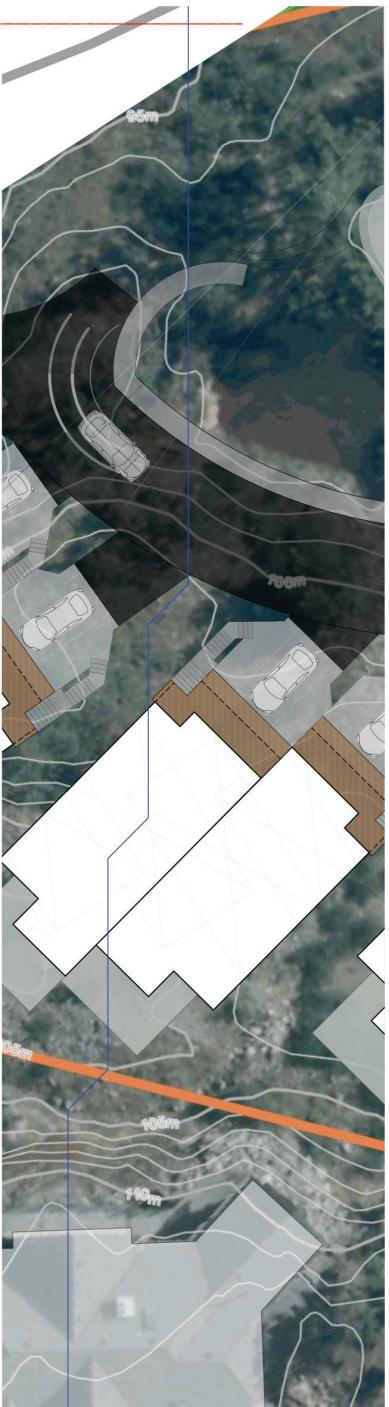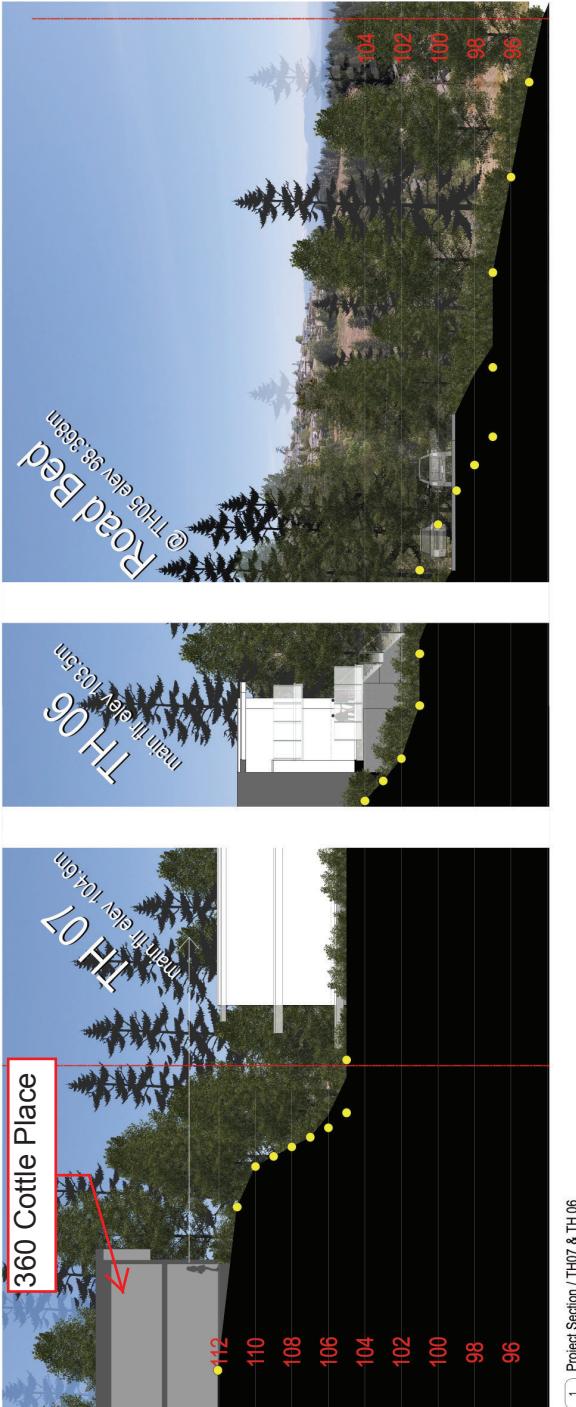

Project Section / Approximate Cut Section at TH07 & TH06
not to scale
A1.5

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Development Permit Application
380 Cottle Place, Nanaimo, British Columbia



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380 Cottle Place
380 Cottle Place, Nanaimo, British Columbia
The ridgeline of Cottle Place, 380 Cottle Place, Nanaimo, British Columbia


Development Permit Application
September 21, 2017
Explanatory Section
February 7th, 2018

project:
380 Cottle Place
380 Cottle Place, Nanaimo, British Columbia
driving site:
380 Cottle Place, Nanaimo, British Columbia
submitting:
Steve Tranfield
2507791914, steve@moddev.ca
moddev.ca
drawing no.:
A1.5
drawing date:
February 7th, 2018
description:
Explanatory Section for Development Permit Application for 380 Cottle Place, Nanaimo, BC.
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ATTACHMENT E RIDGE LINE VIEW



1 Hillslope Aerial View
A15 not to scale

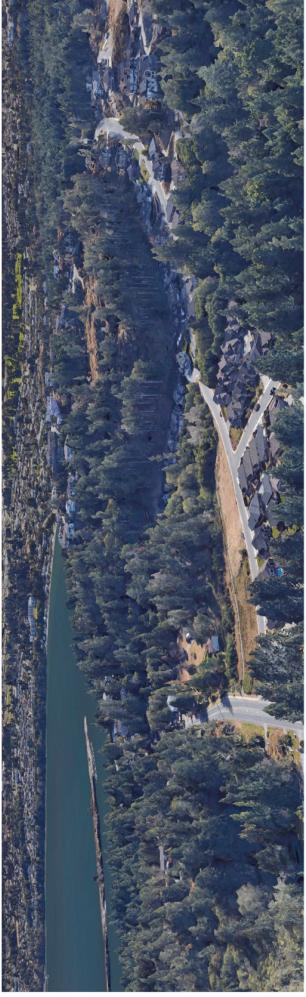

2 Hillslope Aerial View
A15 not to scale



3 Orthographic Project Elevation
A15

View of Single Detached Units stepped back from the Ridgeline.



4 Ridge Site Plan
A15 not to scale



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Development Permit Application
September 21, 2017

380 Cottle Place
380 Cottle Place, Nanaimo, British Columbia
Hillside Aerial Views
Project Revision / Ridge Site Plan
mōdēv
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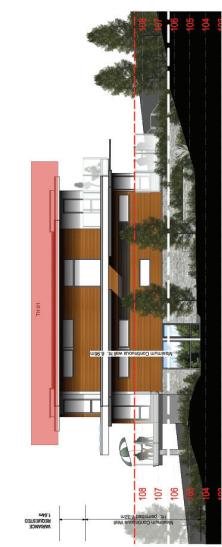
Steve Jamfield
2021/29/1914 steve@modesk.ca
mōdēv
mōdēv

DESIGN LIFE:
mōdēv
mōdēv


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Current Planning

ATTACHMENT F BUILDING ELEVATIONS

TOWNHOUSES




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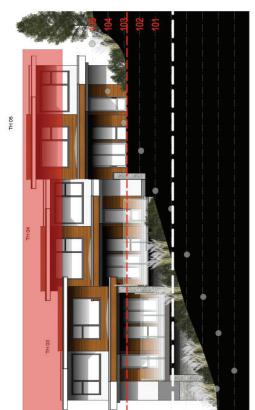
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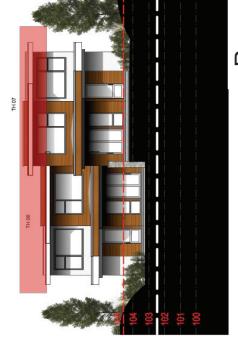
Rear

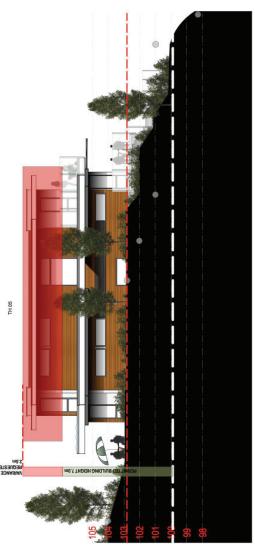

Rear



Rear

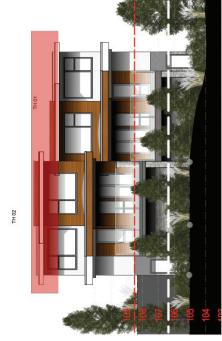


Rear




Front


Proposed Height Variance within Shaded (red) Area

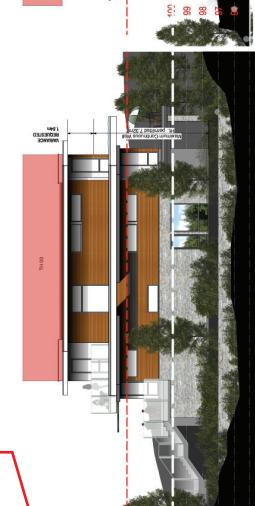


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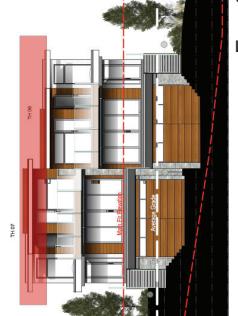
Front

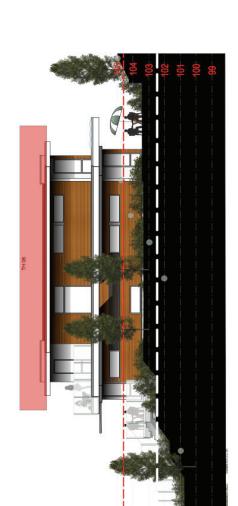

Front

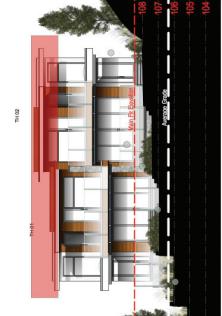

Front

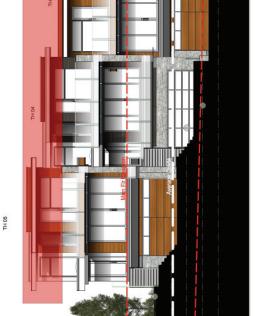

Front

1 TH01&02: Front, Side and Rear Elevation
A3.2 metric scale: 1:1502 TH03-04 & 05: Front, Side and Rear Elevation
A3.2 metric scale: 1:1503 TH06 & 07: Front, Side and Rear Elevation
A3.2 metric scale: 1:150

380 COTTLE PLACE

Development Permit Application

The ridgeline of Cottle Place,


Nanaimo, British Columbia

Development Permit Application	Site Plan H1
Project Name:	COTTLE PLACE
Response to City of Nanaimo Review	February 14, 2018
Project:	380 Cottle Place, Nanaimo, British Columbia
Comments:	None
Site Profile:	None
Building Elevation:	None
Other:	None

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TOWNHOUSES




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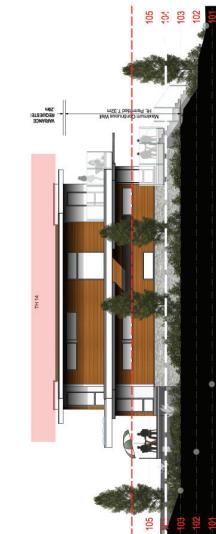
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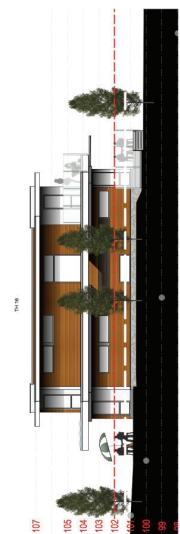
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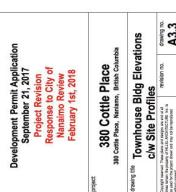
Front

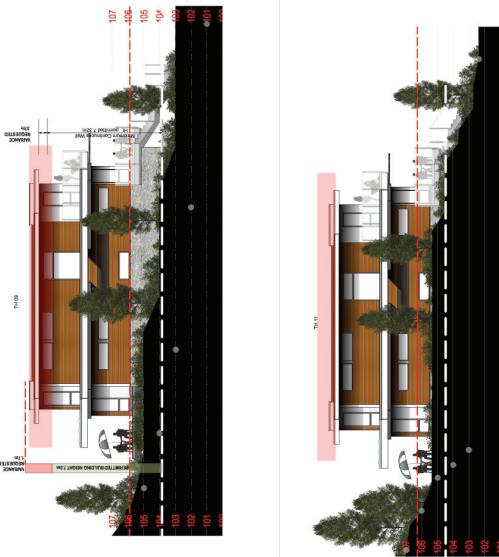

Rear



Rear

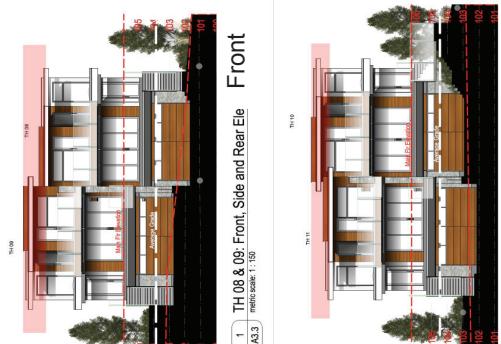

Rear




Development Permit Application
Project Revision
Responses to City of Nanaimo Review
February 14, 2018

The ridgeline of Cottle Place, 380 Cottle Place, Nanaimo, British Columbia



Front

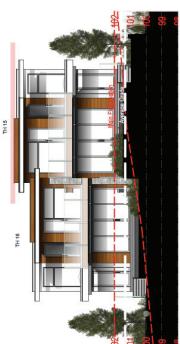


Front



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SINGLE FAMILY RESIDENTIAL UNITS

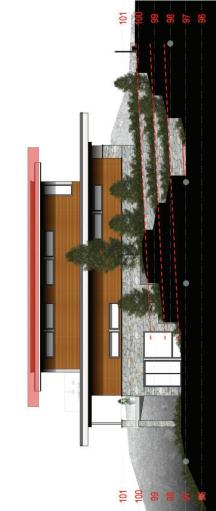

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380 Cottle Place

The ridgeline of Cottle Place, Nainaimo, British Columbia






Development Permit Application
September 21, 2017
Project Revision
Response to City
of Nanaimo Review
February 2018
380 Cottle Place
380 Cottle Place, Nainaimo, BC, British Columbia
Project:
380 Cottle Place
Owner:
Hillel Architecture Inc.
Architect:
Hillel Architecture Inc.
Site Profile:
380 Cottle Place
Address:
380 Cottle Place, Nainaimo, BC, V9R 5G8
Area:
1.00 ha
Zoning:
R-1
Building:
380 Cottle Place
Size:
1,000 m²
Floor Area:
1,000 m²
Lot Size:
1,000 m²
Year Built:
2018
Year Proposed:
2018
Year Completed:
2018
Status:
Approved
Comments:
Approved
Date Approved:
2018-02-22
Signature:
Steve Turnbull
380 Cottle Place, Nainaimo, BC, V9R 5G8
Email:
steve@hillel.ca
Phone:
250-529-1414
Fax:
250-529-1414
File Number:
DP1182
Date:2020-APR-02
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SINGLE FAMILY RESIDENTIAL UNITS

4 of 4



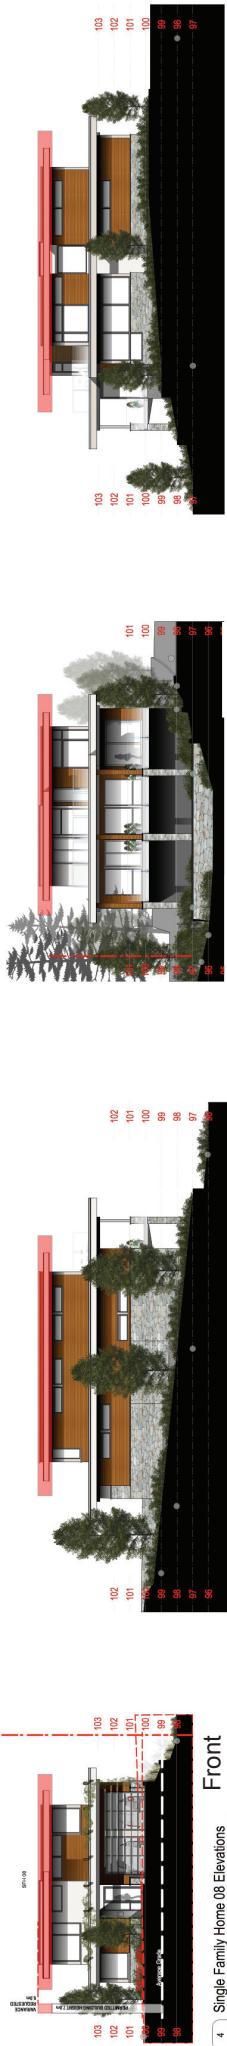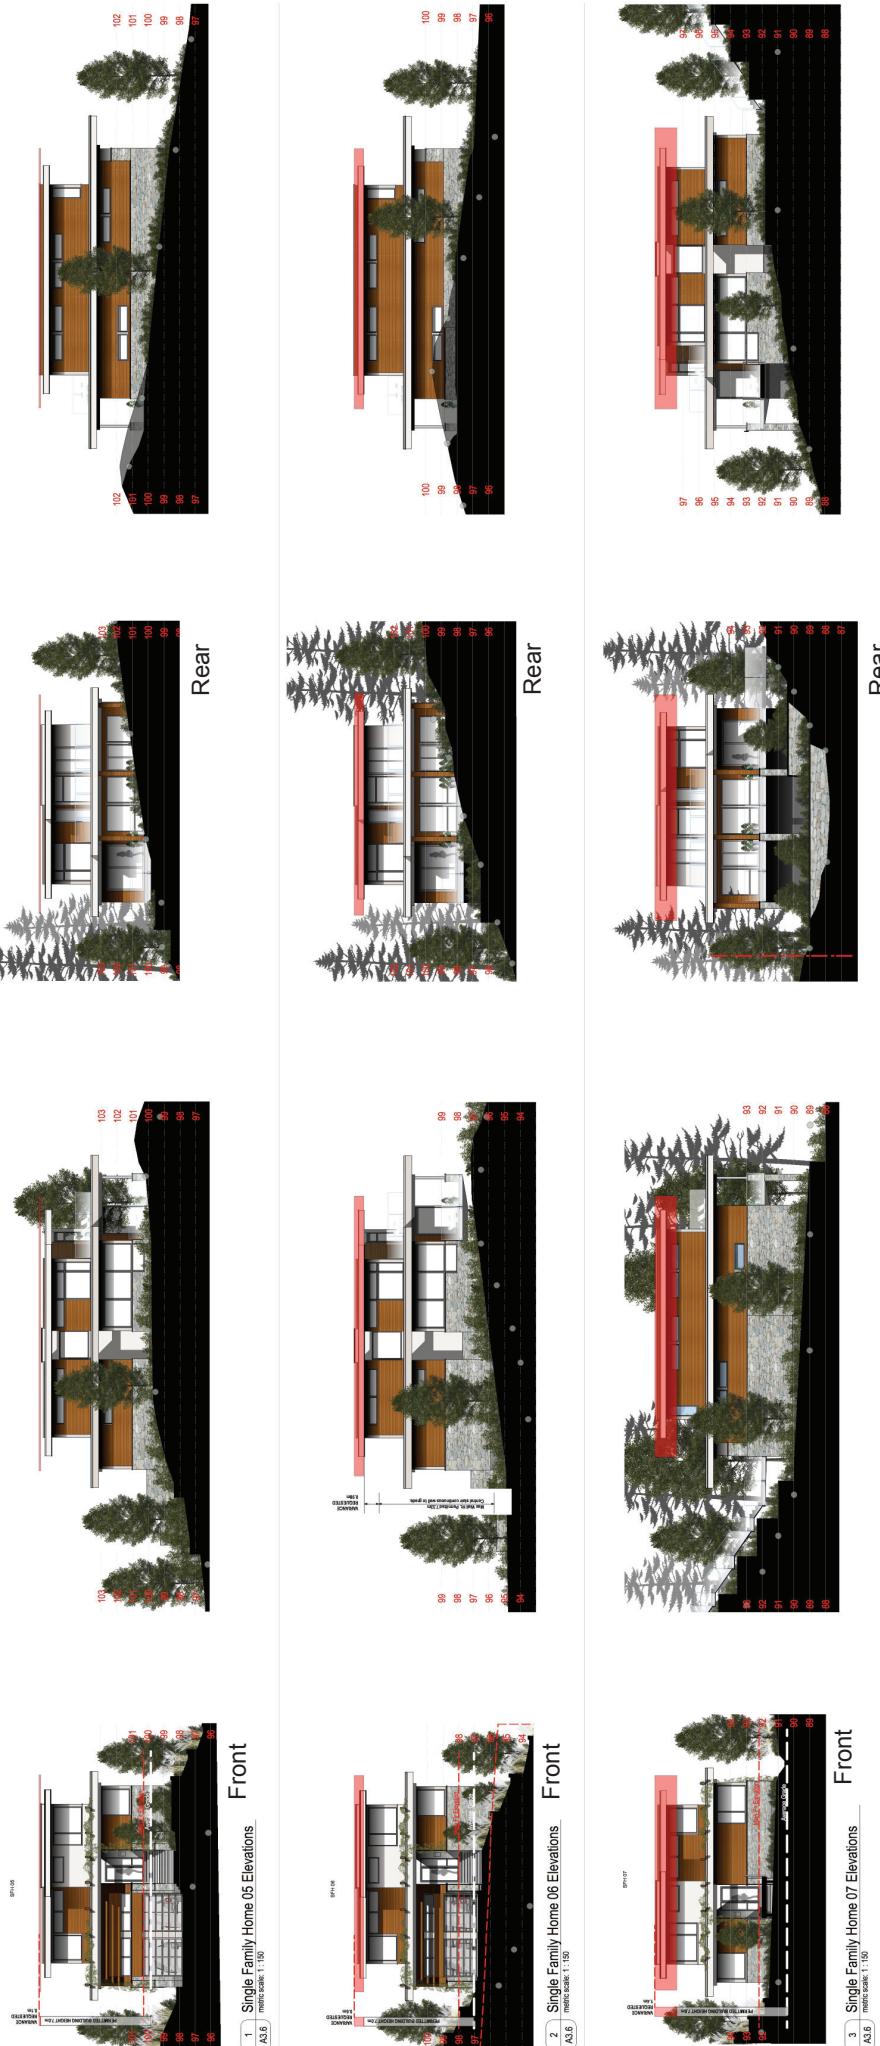

380 COTTLE PLACE

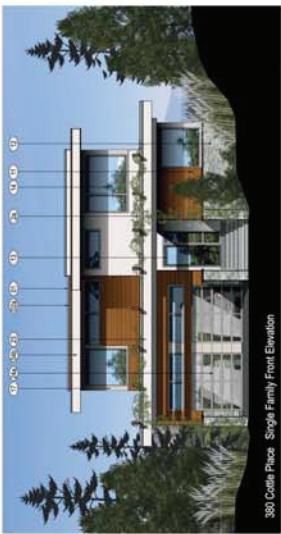Development Permit Application

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Development Permit Application
September 21, 2017

380 Cottle Place
380 Cottle Place, Nanaimo, British Columbia
Single Family Design Elevations
mōdev
modular design

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**ATTACHMENT H
LANDSCAPE PLANS AND DETAILS**



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AND STAMPS AND SIGNATURES ARE NOT TO BE REMOVED.
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E-MAIL:

www.mcdonaldgray.ca

REF ID: 250-544-2309

BML

REF ID: DE-151

WWW.MCDONALDGRAY.CA


REF ID: DE-151

380 COTTLE PLACE
Moddy
Nanaimo, BC
LANDSCAPE ARCHITECTURE
SITE PLAN

REVISION SCHEME	NOTES	DATE	2020-APR-02	OPERATION NUMBER	12 of 7
2	Z5M20207 Pre-application Review	Deemeber 7, 2017	12-250 mtrc	Project Number:	17-0176
1	Z25SP2017 Pre-submission	Deemeber 7, 2017	NG	Date:	1-250 mtrc
0				Comments:	



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LANDSCAPE ARCHITECTURE SITE PLAN NOTES

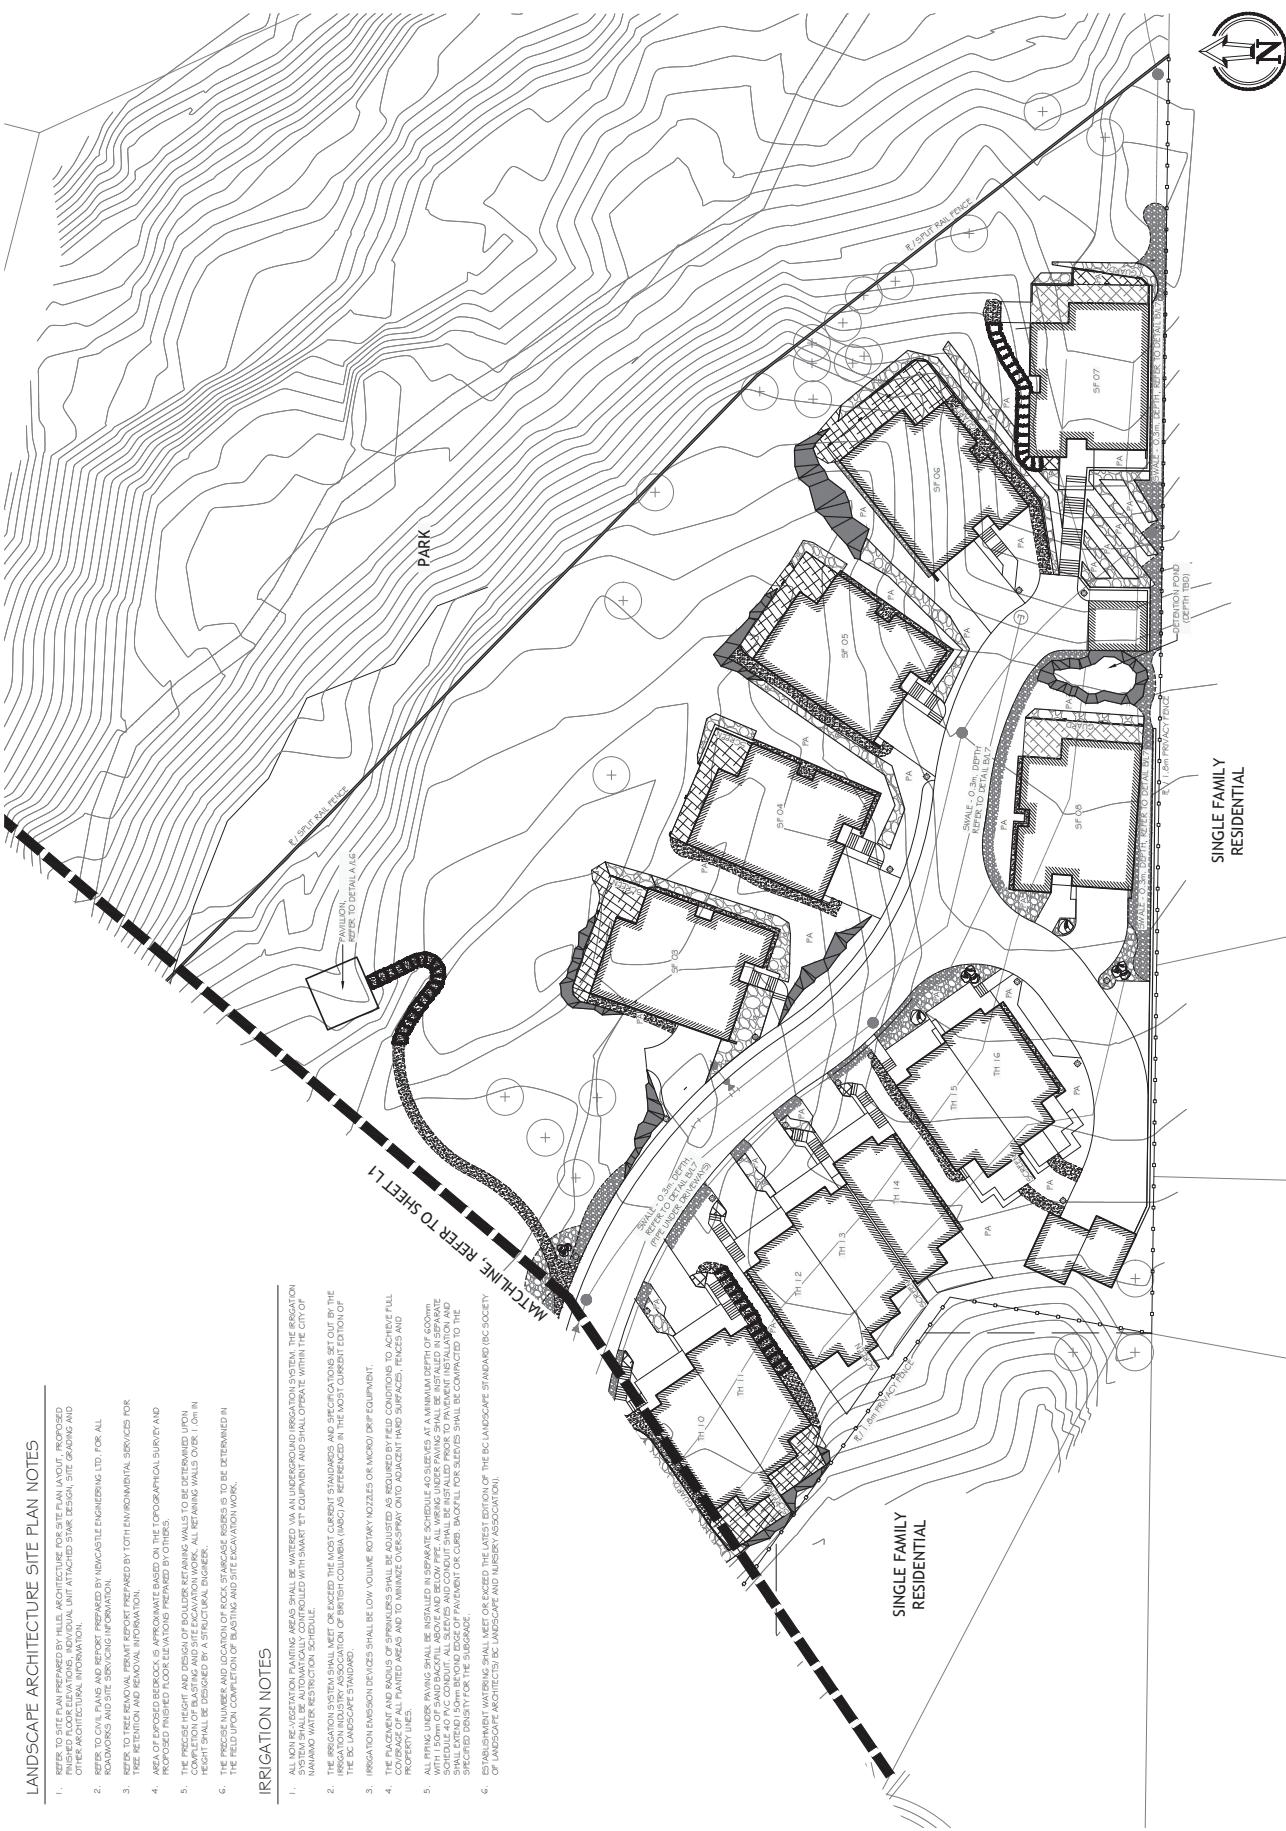IRRIGATION NOTES

1. REFERENCED DOCUMENTS: THIS SITE PLAN LAYOUT IS PROVIDED FOR INFORMATION ONLY. IT IS THE PROPERTY OF THE LANDSCAPE ARCHITECTURE FIRM AND SHALL NOT BE USED FOR CONSTRUCTION. IT IS THE PROPERTY OF THE LANDSCAPE ARCHITECTURE FIRM AND SHALL NOT BE COPIED OR REPRODUCED.
2. REFER TO THE PLANS AND SITE SURVEY INFORMATION FOR ALL ROADWORK AND SITE SPACING INFORMATION.
3. REFER TO THE ENVIRONMENTAL REPORT PREPARED BY TOTEN ENVIRONMENTAL SERVICES FOR TREE RETENTION AND REMOVAL INFORMATION.
4. AREA OF DUGGED BOREHOLES IS APPROXIMATE AND SHOULD BE DETERMINED ON THE TOPOGRAPHICAL SURFACE AND PROPORTIONED TO THE CONSTRUCTION WORKS PROVIDED BY OTHERS.
5. THE PROGRESS NUMBER AND LOCATION OF ROCK AND STONE STOREAGE SITES IS TO BE DETERMINED IN THE FIELD UPON COMPLETION OF BLASTING AND SITE EXCAVATION WORK.
6. THE PROGRESS NUMBER AND LOCATION OF ROCK AND STONE STOREAGE SITES IS TO BE DETERMINED IN THE FIELD UPON COMPLETION OF BLASTING AND SITE EXCAVATION WORK.

3 of 7
PLANTING PLAN - WEST



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380 COTTLE PLACE

Mödevy
Nanaimo, BC

PLANTING PLAN	13 of 7
DRAWING NUMBER:	
Date:	December 7, 2017
Checklist:	NG
Scale:	1:250 metric
Project Number:	17-0176
2 ZESPE2017 Pre-Submission Review	
1 ZESPE2017 Pre-Application Review	
0 ZESPE2017 Pre-Development Review	
Revision Schedule	
NOTES	

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PLANTING PLAN - EAST



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Nanaimo, BC

PLANTING PLAN	Date:	December 7, 2017	
Drafter:	CM	Checked:	NG
Scale:	1:250 metric	Project Number:	17-0176
DRAWING NUMBER:		DRAWING NUMBER:	

380 Cottle Place

#	Date	NOTES
0	25SEP2017	Pre-qualification Review
1	26SEP2017	DP Submission
2	07DEC2017	DP Re-submission



LANDSCAPING DETAILS



Model
Nanaimo, BC

380 Cottle Place

REVISION SCHEME	NOTES	DATE	DECEMBER 7, 2017	OPERATION NUMBER	DP1182	DRAWING NUMBER	75
2	25A12017 Pre-Submission Review	Pre-Submision Review	NO	Scale	1:100 metric	Project Number:	17-0176
1	25S12017 Pre-Approval Submission	Submission	NO	Date:	December 7, 2017	Drawn by:	

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Typical Duplex/Triplex Landscape
1:100 metric



Typical Single Family Landscape
1:100 metric

PLANTING NOTES

1. ALL SOILS SHALL BE TOPSOIL AND NOT SUBSTITUTED. NO SUBSTITUTIONS OR CUT OUTS ARE ALLOWED. NO SUBSTITUTIONS ARE ALLOWED FOR THE FOLLOWING STANDARD PLANT MATERIALS AS ASSOCIATED ON THE DRAWS. LANDSCAPE ARCHITECTS B.C. LANDSCAPE STANDARD.
2. ALL PLANTS SHALL BE PLANTED WITH 300MM OF TOPSOIL OR WEEDED ORGANIC SOIL AROUND AND BELOW THE PLANTING LINE.
3. SOIL DEPTHS: SHRUBS - 300mm
TREES - 300mm AROUND AND BELOW ROOTBALL.
4. MULCH DEPTH SHALL BE 75mm MINIMUM OVER ALL TREES AND SHRUB PLANTING AREAS.
5. PLANT MATERIAL QUALITY, TRANSPORT AND HANDLING SHALL COMPLY WITH BOTANICAL STANDARDS FOR NURSERY STOCK.
6. ALL PLANTING AREAS SHALL BE WATERED VIA UNDERGROUND AUTOMATIC IRRIGATION SYSTEM, IRRIGATION EQUIPMENT DEVICES SHALL BE BELOW GROUND ROTARY SPRINKLERS OR MICRO Drip EQUIPMENT.
7. PLANT QUANTITIES ARE FOR INFORMATION ONLY. IN CASE OF ANY DISCREPANCY, THE PLAN SHALL GOVERN.
8. ALL PLANT MATERIAL SHALL MATCH SPECIFICATIONS AS INDICATED ON THE PLANTING LEGEND.
9. CONTACT THE LANDSCAPE ARCHITECT FOR APPROVAL OF ANY SUBSTITUTIONS. NO SUBSTITUTIONS WILL BE ACCEPTED WITHOUT PRIOR WRITTEN APPROVAL OF THE LANDSCAPE ARCHITECT.
10. CHECK PLANT LOCATIONS FOR EXISTING WATER LINES AND OTHER UNDERGROUND SERVICES PRIOR TO DIGGING TREE Holes. EXCAVATED PLANT PITS SHALL HAVE DRAINS. PLANTS WHEN FULLY FLOODED WITH WATER SHALL DRAW WITHIN ONE HOUR TILLING.
11. NO PLANTS REQUIRING PRUNING OF MAJOR BRANCHES DUE TO DISEASE, DAMAGE OR POOR FORM WILL BE ACCEPTED.
12. ALL CALIFORNIA STOCK TREES SHALL BE B & B IN WIRE BASKETS.

PLANT LEGEND		SIZE				SPACING		QUANTITY		NOTES			
SYMBOL	BOTANICAL / COMMON NAME		1.5m BUFFER	#5 POT	SEED PLAN	28	NATIVE SPECIES			SIZE	SPACING	QUANTITY	NOTES
	ACER GEMINATUM SWEET MAPLE			#5 POT	SEED PLAN	6	NATIVE CULTIVAR; STREET TREE			9cm POT	TBD	25	WHERE THE SUBGRADE DOES NOT ALLOW FOR SOIL VOLUMES AND SPACING REQUIRED IN THE PLANTING END AND PLANTING NOTES ARE DISTURBED ROCK OUTCROPS, STAMPS ARE TO BE APPLIED IN CRACKS, HOLES AND 1. GAPS IN EARTHWORK, AS INDICATED IN THE GROWING MEDIUM.
	CERCIS CANADENSIS FOREST PANSY		5cm CAL.		SEED PLAN	5	NATIVE CULTIVAR			9cm POT	TBD	25	2. QUANTITIES ARE BASED ON 25% SUITABLE PLANTING AREAS AT 1.0m SPACING.
	CHAMAECYPARIS NOOTKAESQUE JUBILEE WEeping ALASKAN CEDAR		5cm CAL.		SEED PLAN	5	NATIVE CULTIVAR			#1 POT	TBD	25	3. QUANTITIES ARE BASED ON 25% SUITABLE PLANTING AREAS AT 1.0m SPACING.
	CORNUS KOUSI SAKURA RED FLOWERING KOREAN DOGWOOD		5cm CAL.		SEED PLAN	5	NATIVE SPECIES			#1 POT	TBD	25	IRRIGATION WILL NOT BE REQUIRED IN THESE AREAS, WHERE FEASIBLE.
	MALUS BLOOM'S CRAB APPLE		5cm CAL.		SEED PLAN	3	NATIVE SPECIES			#1 POT	TBD	25	DROUGHT TOLERANT
	PICEA ABIES CUPRESSINA		5cm CAL.		SEED PLAN	5	NATIVE SPECIES			#1 POT	TBD	25	STREET TREE
	PRUNUS GALLIPERIA CHANTRELL' REDESP'R FLOWERING PEAR		5cm CAL.		SEED PLAN	5	NATIVE SPECIES			#1 POT	TBD	25	
	AMELANCHIER ALNIFOLIA SAGRARIOON		#5 POT		#1 POT	203	NATIVE SPECIES			9cm POT	TBD	15	
	Gaultheria shallon SALAL		#2 POT		#1 POT	1.5m O.C.	NATIVE SPECIES			10cm POT	TBD	15	
	HODOSIA DISCOLOR OCEANSpray		#2 POT		#2 POT	1.5m O.C.	NATIVE SPECIES			#1 POT	TBD	15	
	MACHAEROPHYLLA OREGON GRAPE		#2 POT		#1 POT	1.0m O.C.	NATIVE SPECIES			#1 POT	TBD	15	
	POSYCHITIA MUNTUM SWOZERIANA		#2 POT		#1 POT	1.20m O.C.	NATIVE SPECIES			#1 POT	TBD	15	
	ROSA GYMNOCARPA BALDWIN ROSE		#1 POT		#1 POT	2.0m O.C.	NATIVE SPECIES			#1 POT	TBD	15	
	SALIX COLUBRINA SCOULER'S WILLOW		#5 POT		#5 POT	1.5m O.C.	NATIVE SPECIES			9cm POT	TBD	15	
	SAMBUCUS RAZZIOSA RED ELDERBERRY		#1 POT		#1 POT	1.0m O.C.	NATIVE SPECIES					1	
	SYRINGA DOUGLASII HARDHACK												
	TEPHRANTHES GROUNDCOVERS												
	ACHILLEA MILLEFOLIUM YARROW		#1 POT		#1 POT	0.6m O.C.	NATIVE CULTIVAR; 30% YELLOW, 30% RED AND 30% ORANGE			#1 POT	TBD	1	
	ARCTOSTAPHYLOS UVA-ROSAE KINNIKNUCK		#1 POT		#1 POT	1.0m O.C.	NATIVE SPECIES; PLANT OVER TOP OF WALLS TO GROW OVER			#1 POT	TBD	1	
	CAREX OSTRUMIA STRAITA SEDGE		#1 POT		#1 POT	0.5m O.C.	NATIVE SPECIES			#1 POT	TBD	1	
	DIGITALIS PURPUREA COMMON FOXGLOVE		#1 POT		#1 POT	1.0m O.C.	DROUGHT TOLERANT			#1 POT	TBD	1	
	JUNCUS EFFUSUS COMMON RUSH		#1 POT		#1 POT	0.6m O.C.	NATIVE SPECIES			#1 POT	0.3m O.C.	95	CENTRELINE OF SWALE
	PELargonium Horticola 'NAME IN PARENTHESIS' FOUNTAIN GRASS		#1 POT		#1 POT	0.5m O.C.	DROUGHT TOLERANT			#1 POT	0.3m O.C.	190	50% SLOPES OF SWALE
	SCIRpus MERICARPUS SMALL FLOWERING BURRUSH		#1 POT		#1 POT	1.0	NATIVE SPECIES			#1 POT	0.5m O.C.	190	BOTTOM CORNERS OF SWALE
	LAWN	900	sq.m.										

380 Cottle Place **Model** **Nanaimo, BC**

PLANTING LEGEND & DETAILS

Symbol	Botanical / Common Name	Common Name	Native Species Re-vegetation Matrix	Native Vegetation Matrix Slopes Disturbed Rock Outcrops + Rock Walls	Size	Spacing	Quantity	Notes
	NORTH & EAST TERRACED DIGITALIS PURPUREA COMMON FOXGLOVE	GALIOTHEA SHALLOON SALAL	LONICERA CILIOLA LONGLEAF OREGON GRAPE	MARIGA NEWFOYA LONGLEAF OREGON GRAPE	9cm POT	TBD	25	WHERE THE SUBGRADE DOES NOT ALLOW FOR SOIL VOLUMES AND SPACING REQUIRED IN THE PLANTING END AND PLANTING NOTES ARE DISTURBED ROCK OUTCROPS, STAMPS ARE TO BE APPLIED IN CRACKS, HOLES AND 1. GAPS IN EARTHWORK, AS INDICATED IN THE GROWING MEDIUM.
	WEST TERRACED ACHILLEA MILLEFOLIUM YARROW	BROADLEAF MINTATHINA FOOL'S COMFORTER	HOLODISCUS DISCOLOR OCEANSpray	MARIGA AQUIFOLIUM OREGON GRAPE	#1 POT	TBD	25	2. QUANTITIES ARE BASED ON 25% SUITABLE PLANTING AREAS AT 1.0m SPACING.
	SOUTH & WEST TERRACED ACHILLEA MILLEFOLIUM YARROW	BALDWIN ROSE	SUDAN SPATHIFOLIUM BROAD-LEAVED STONECROP	MONTIA PARVIFLORA SMALL-LEAVED MONTIA ROSA GYMNOCARPA BALDWIN ROSE	9cm POT	TBD	15	3. QUANTITIES ARE BASED ON 25% SUITABLE PLANTING AREAS AT 1.0m SPACING.
	EAST TERRACED CAREX OSTRUMIA STRAITA SEDGE	SCOUERIA SULLIVAN'S WILLOW	SCIRpus MERICARPUS SMALL FLOWERING BURRUSH	SPREADER DOUGLASII HAPHAZOC	#1 POT	TBD	1	LONINE (SOUTHERN) POND CAREX OSTRUMIA STRAITA SMOOTH SWALE
	WALL PLANTING JUNCUS EFFUSUS COMMON RUSH	SALIX SCOUERIANA SCOUERIA SULLIVAN'S WILLOW	SCIRpus MERICARPUS SMALL FLOWERING BURRUSH	CAREX OSTRUMIA STRAITA SMOOTH SWALE	#1 POT	TBD	1	
	SWALE PLANTING JUNCUS EFFUSUS COMMON RUSH	SCIRpus MERICARPUS SMALL FLOWERING BURRUSH	SPREADER DOUGLASII HAPHAZOC	CAREX OSTRUMIA STRAITA SMOOTH SWALE	#1 POT	TBD	1	

NOTES

- 1. ALL OF EARTHWORK INDICES IS INFLUENCED BASED ON THE EARTHWORK, SURFACE AND ROCKWORK INDICES REFERRED TO IN THE PLANS.
- 2. THE PROPOSED HEIGHT AND DEPTH OF BOUNDARY RETAINING WALLS TO DETERMINE THE EARTHWORK INDICES REFERRED TO IN THE PLANS.
- 3. THE PROPOSED NUMBER AND LOCATION OF ROCK STACKERS REFERRED TO IN THE PLANS.

SECTION

A Pavilion **Section A Location**

B Split Rail Fence **Part B Section B Location**

SECTION

ELEVATION

SECTION

B **Split Rail Fence** **Part B Section B Location**

1.150 metric

1.125 metric

DRAWING NUMBER: L6 of 7 **DATE:** 25/02/2017 **DESIGNER:** Pre-Approval Reviewer **CHIEF:** AS NOTED **SCALE:** 1:50 **PROJECT NUMBER:** 25520207 **PRE-APPROVAL NUMBER:** 177-0176

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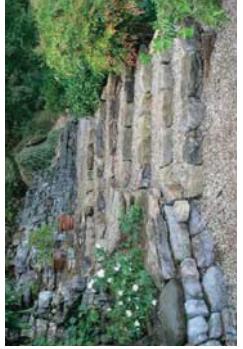
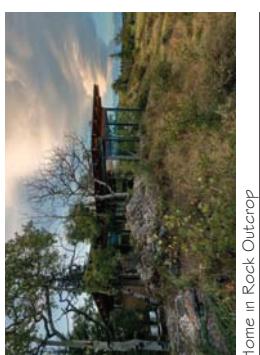
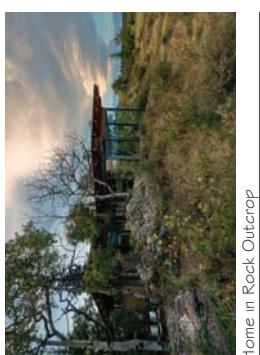
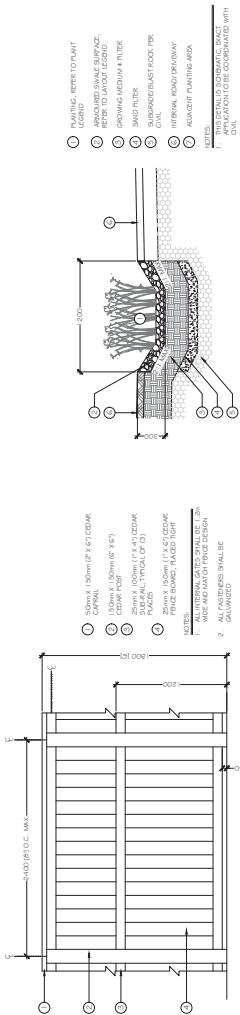
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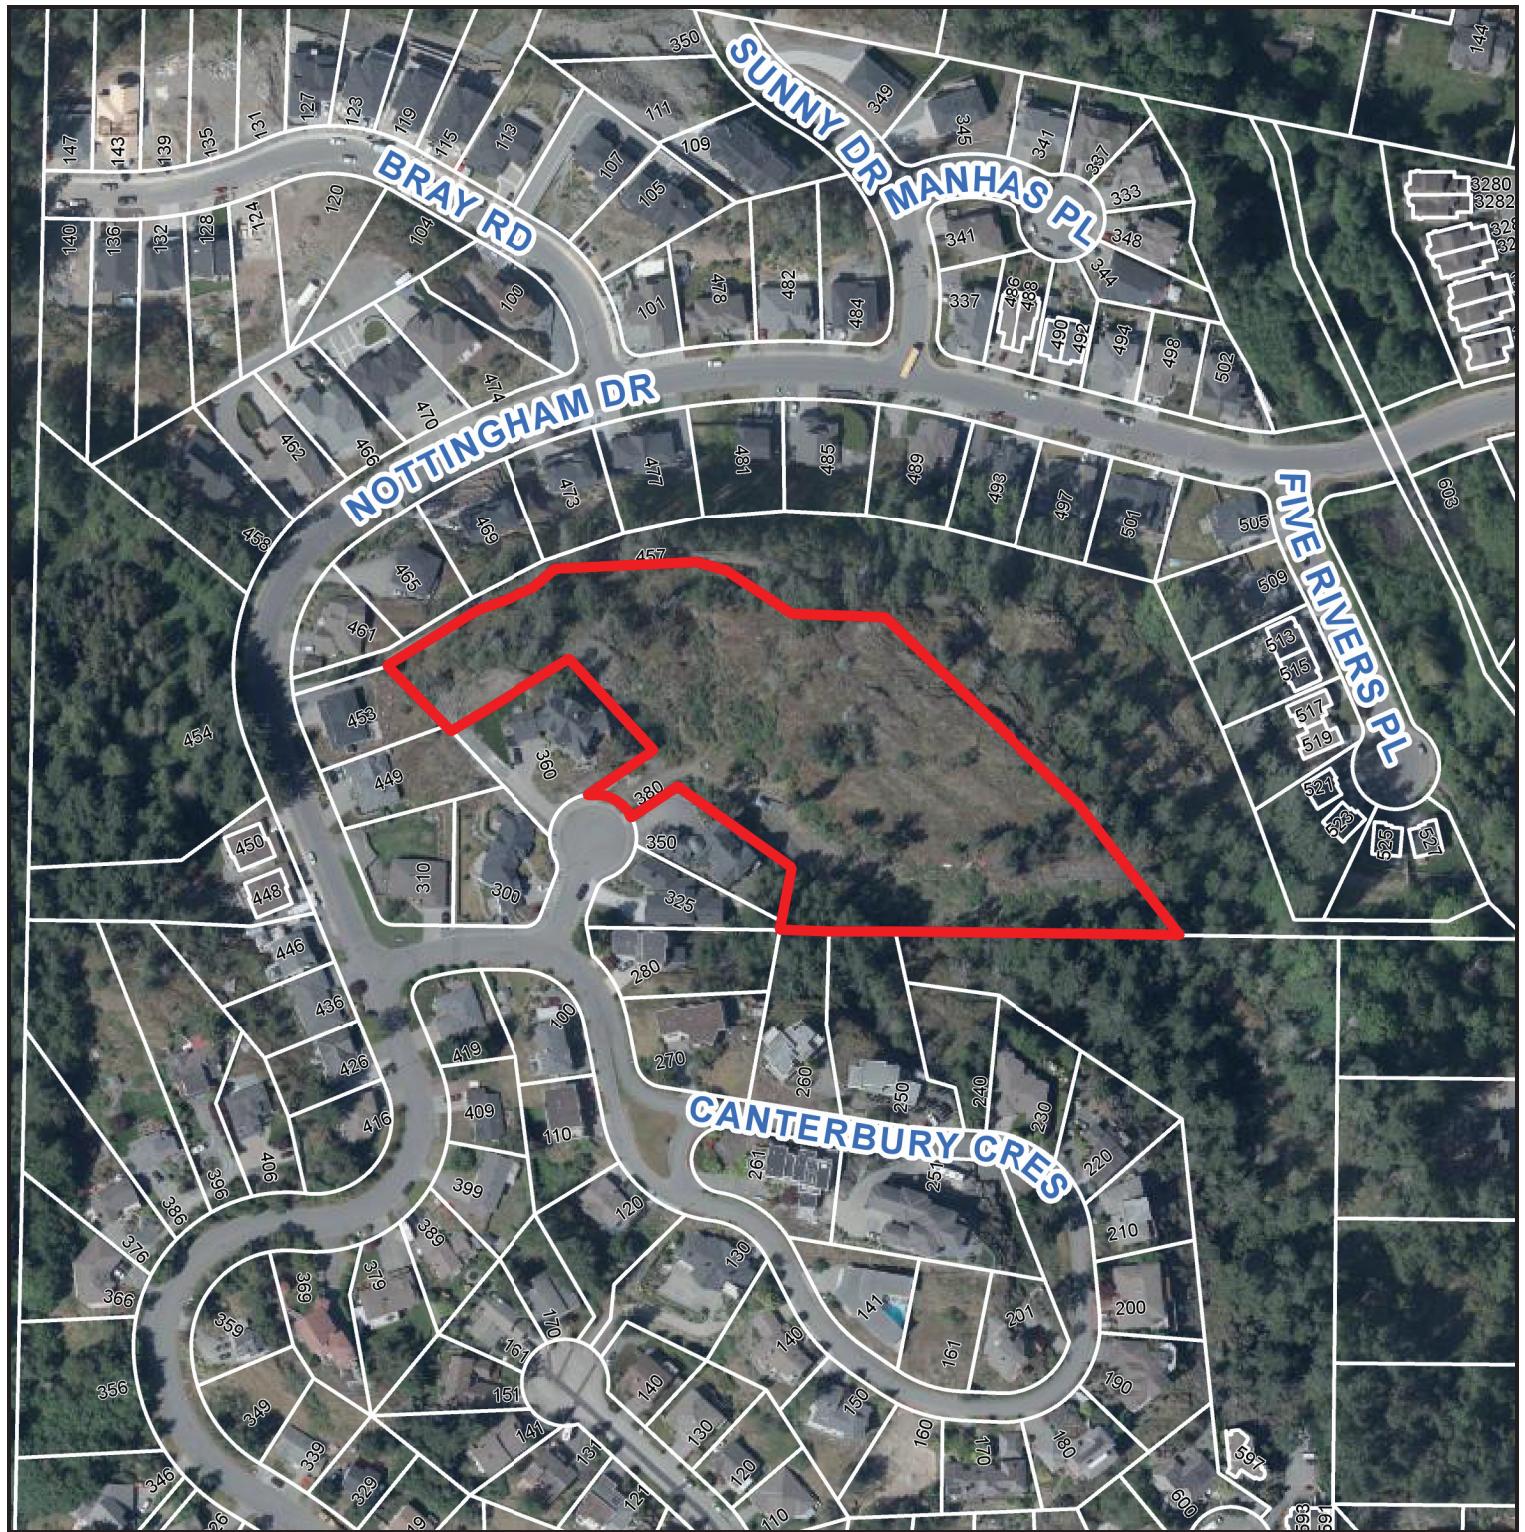
REVISIONS SHEET NUMBER	7 of 7
DATE	25AUG2017
PRE-APPLICATION REVIEW	26SEP2017
DEPARTMENT	Planning
DEPARTMENT NUMBER	17-A0176
SCALE	1:250 metric
PROJECT NUMBER	NG
DATE	December 7, 2017
NOTES	

REVISIONS SHEET NUMBER	7 of 7
DATE	25AUG2017
PRE-APPLICATION REVIEW	26SEP2017
DEPARTMENT	Planning
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SCALE	1:250 metric
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ATTACHMENT I
AERIAL PHOTO



DEVELOPMENT PERMIT NO. DP001182

 380 COTTLE PLACE

Delegation Request

Delegations Information:

Steven Tranfield and Peter Hardcastle has requested an appearance before Council.

City: Nanaimo
Province: BC

Delegation Details:

The requested date is June 1, 2020.

The requested meeting is:
Council

Bringing a presentation: Yes

Details of the Presentation:

Peter Hardcastle will speak to details of the design and the requirement for height variance due to topography. Steven will speak to the development as part of the community.